


Full Size or Largest Size Plans
Site Plan
Landscape Plan
Elevations

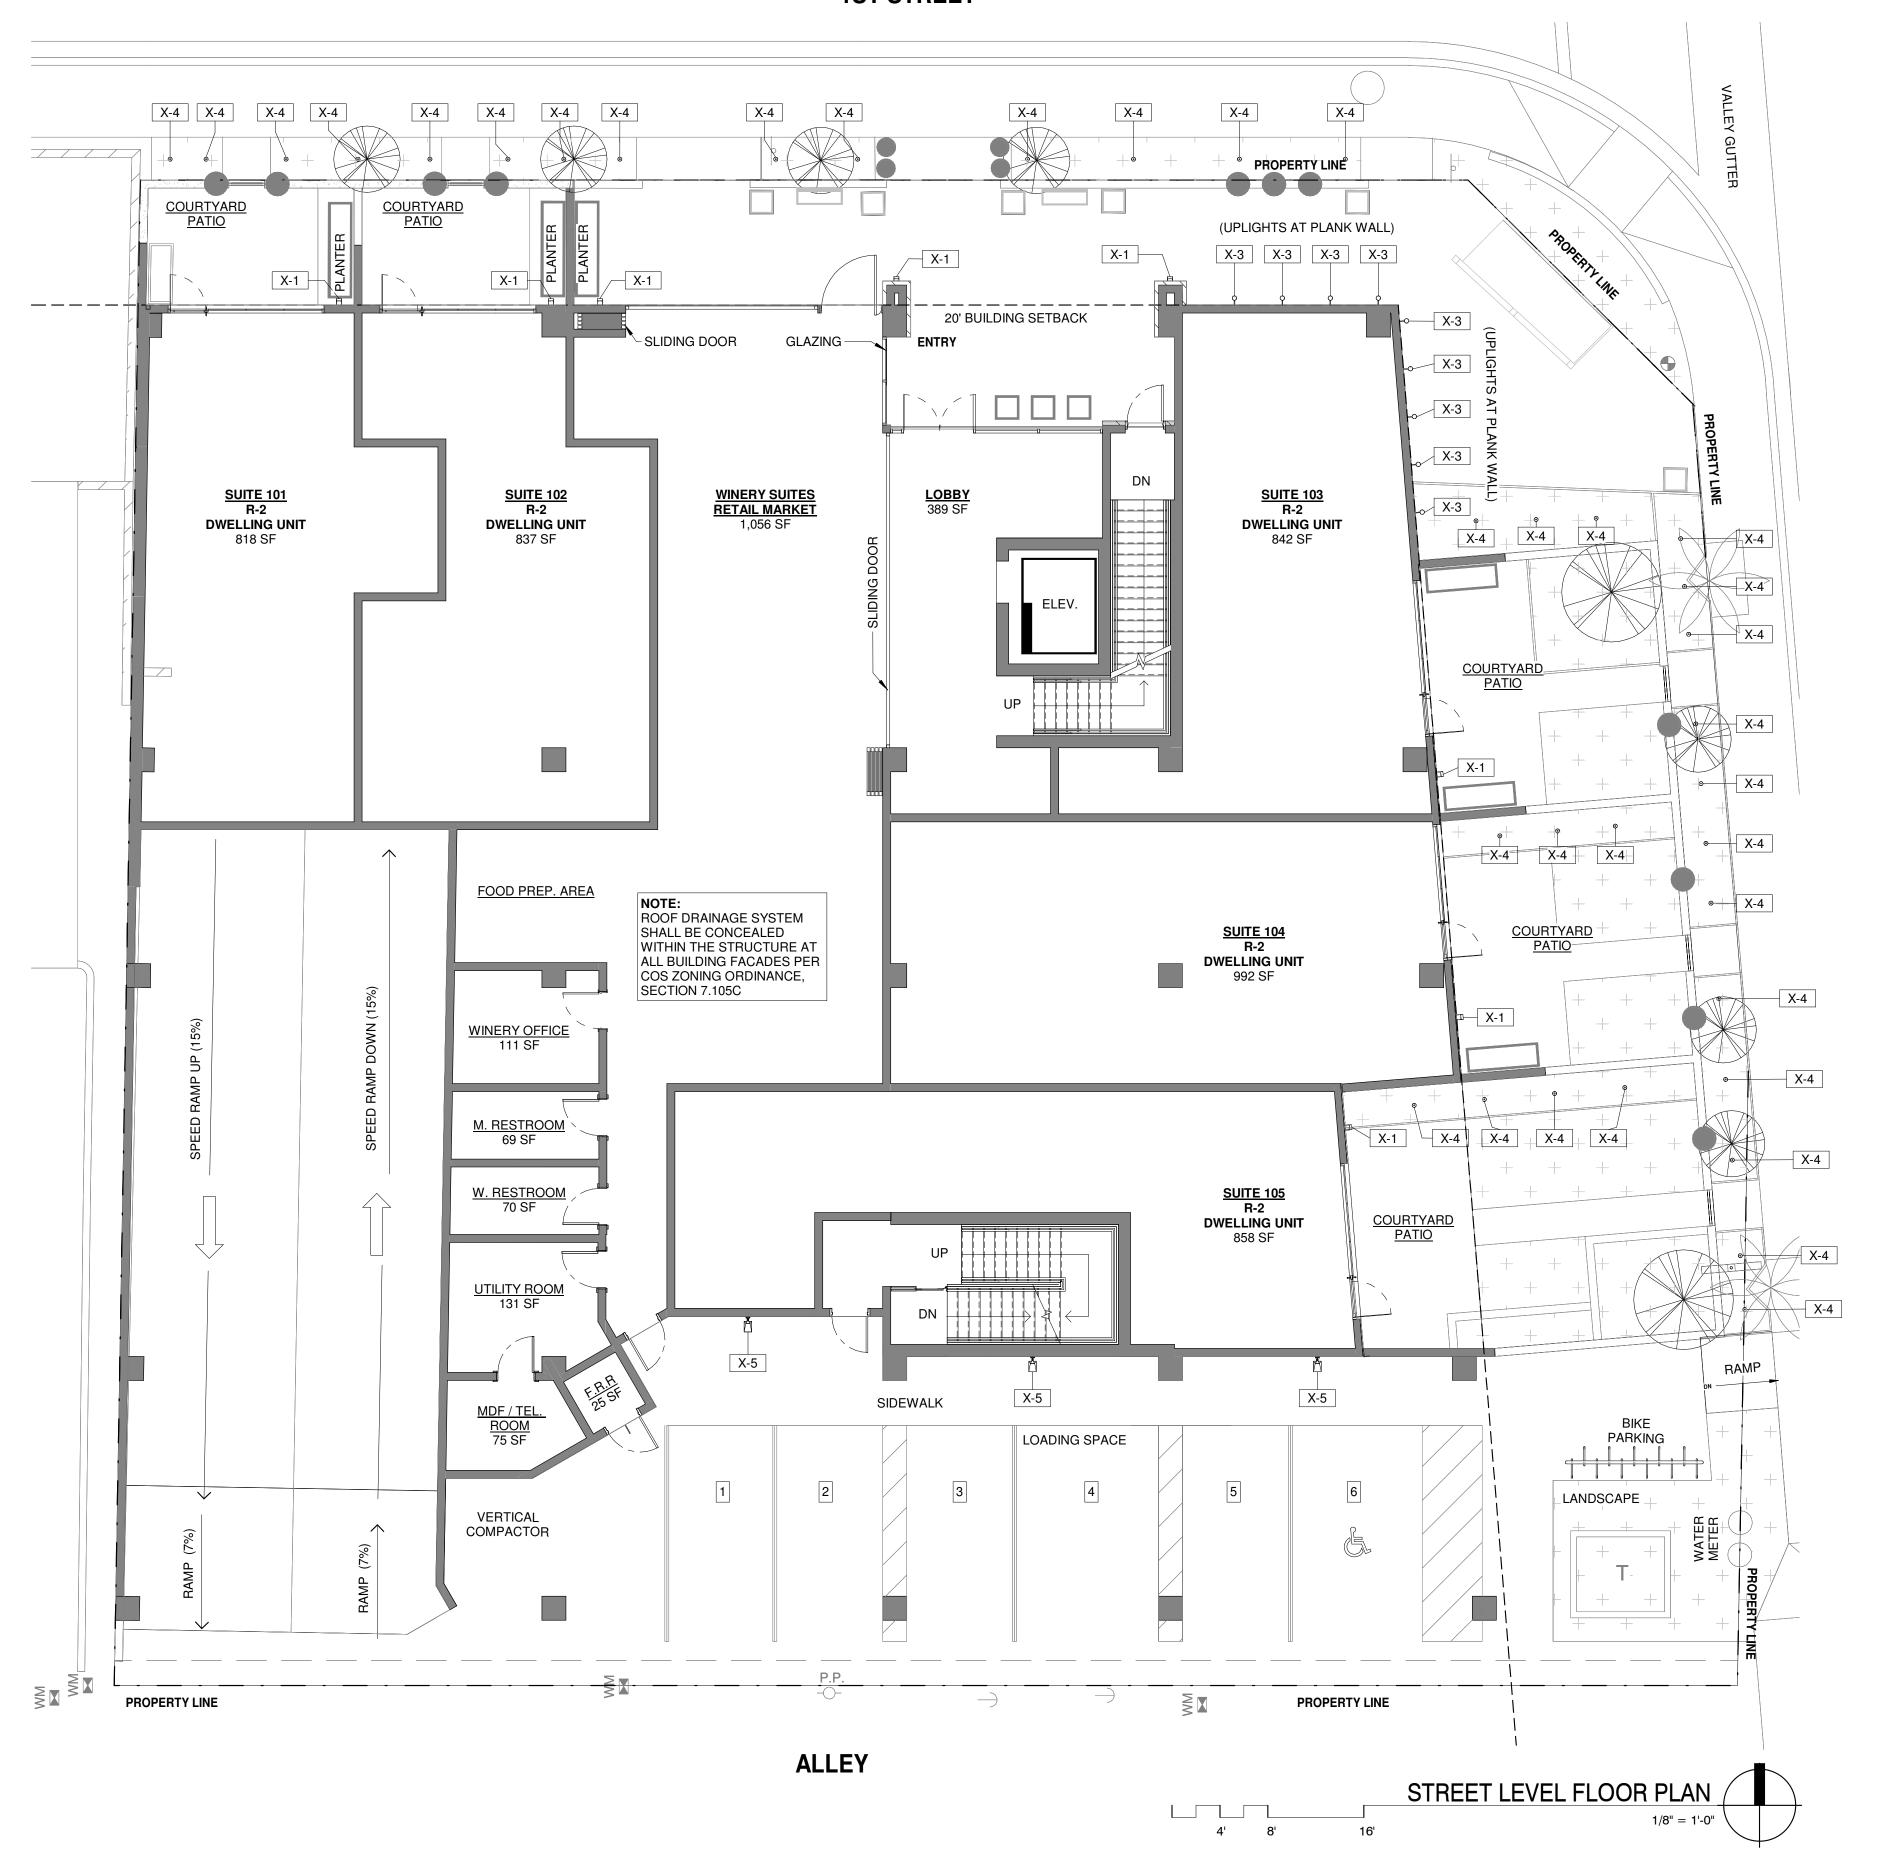

TYPE MARK	MODEL	MANUFACTURER	LAMP TEMP	LAMP	DESCRIPTION
X-1	C-AR-FS-20-LED-391 -BP-WHT-120	TEKA LIGHTING	3000 K	10W LED	ARCADE SERIES 20" EXTERIOR WALL SCONCE, WALL MOUNTED AT 7' TO CENTER OF FIXTURE, AT PATIO AND ENTRY
X-2	C-SWM-LED-L11-BP- S-CRW	TEKA LIGHTING	3000 K	10W LED	EXTERIOR WALL MOUNTED DOWNLIGHT SINGLE HEAD FULLY ADJUSTABLE DIRECTIONAL FLOODLIGHT, MOUNTED 8'6" TO CENTER OF FIXTURE
X-3	C-PNF-6"-LED-E65- MFL-A9-BP-12-11-C- POWER CANOPY	TEKA LIGHTING	3000 K	8W LED	SINGLE HEAD FULLY ADJUSTABLE DIRECTIONAL FLOODLIGHT WITH PAR30 LED RETROFIT LAMP,UP LIGHT AT PLANK WALL AND STONE TOWER
X-4	C-HLP-12"-C-LED-E7 1-BP	TEKA LIGHTING	3000 K	3W LED	12" STEM HEIGHT BOLLARD LIGHTING FIXTURE AT LANDSCAPE AND PATHWAY
X-5	iTEKA LED	iCUZZINI	3000 K	20W LED	FLOODLIGHT INTENDED FOR USE WITH LED LIGHT SOURCES, WALL MOUNTED AT 7'6"TO CENTER OF FIXTURE, AT PARKING AND MECH ROOM
X-6	DM-LED-E10-AQW	LITON	3000 K	3W LED	EXTERIOR RECESSED LED PUCK LIGHT, PINHOLE TRIM, NEW CONSTRUCTION HOUSING, 3000K, WHITE PINHOLE, BLACK REFLECTOR.
X-7	BPM-SD12-LED-X84- BP-S-PT-D23-MT	TEKA LIGHTING	3000 K	23W LED	6' HEIGHT POLE MOUNT SOLID STATE LIGHTING FIXTURE AT VIEWING DECK



DESIGNERS OF PROGRESSIVE ARCHITECTURE
7272 e indian school rd ste 214 scottsdale, arizona 85251 telephone 480 941 4222 www.dpaarchitects.com

#: Description: Date:

drawn by: Authorized project no.: 180 date: 11/13/

EXTERIOR LIGHTING SITE PLAN

CITY OF SCOTTSDALE REZONING/DR DEVELOPMENT SUBMITTAL PRE-APP CASE #486 - PA - 2018 AS102

20" ARCADE FULL SHIELD (FS)

TEKA

TYPE: X-1

CATALOG NUMBER LOGIC

C AR	FS	20	LED	391 BP W	/HT 120	
Example - AR -	FS -	20 -	LED	- 390 - BLP - H	IRN - 120 -	
Material —						
Blank - Aluminum						
C - Copper						
S - Stainless Steel						
Series						
AR - Arcade						
Style —						
FS - Full Shield						
Wall Plate —						
20 - 20 Inch						
Source —						
LED - Solid State System						

LED Type —						
390 - 10WLED/2700K						
391 - 10WLED/3000K						
392 - 10WLED/4000K						
Finish —			0.000 -2.00			
NAT - Natural* (Copper and Stainless only.)	Powder Coat				Powder Coat Premium Finish	1
BP - Brown Patina* (Copper only.)	Powder Coat Color		Wrinkle	ABP Antique Brass Powder	CMG Cascade Mountain Granite	RMG Rocky Mountain Granite
GP - Green Patina* (Copper only.)	Bronze	BZP	BZW	AMG Aleutian Mountain Granite	CRI Cracked Ice	SDS Sonoran Desert Sandston
NIC - Nickel Plate* (Copper only.)	Black	BLP	BLW	AQW Antique White	CRM Cream	SMG Sierra Mountain Granite
POL - Polish* (Copper and Stainless only.)	White (Gloss)	WHP	WHW	BCM Black Chrome	HUG Hunter Green	TXF Textured Forest
BRU - Brush* (Stainless only.)	Aluminum	SAP		BGE Beige	MDS Mojave Desert Sandstone	WCP Weathered Copper
BZW - For Aluminum fixtures, specify Standard or Premium Powder Coat.	Verde	_	VER	BPP Brown Patina Powder	NBP Natural Brass Powder	WIR Weathered Iron Also available in RAL Finishes
				CAP Clear Anodized Powder	OCP Old Copper	See submittal SUB-1439-00
Diffuser —					_	
WHT - Translucent White						
ALB - White Alabaster						
ROS - Rose Alabaster						
HRN - Natural Horn						
CAR - Carmel						
RAD - Radiant Flame						
Input Voltage —						

120 - 120 VAC **277** - 277 VAC

ART - Laser Engraved Faceplate Art

AC Input Range	Output Range	Frequency Hz	Power Factor At Full (Efficiency)	Load T	HD	Operation Ambient Temperature
120V	12V	50/60 Hz	>.98	<.	13%	-10°F to 130° F (-23° C to 54° C)
277V	12V	50/60 Hz	>.97	<.	13%	-10°F to 130° F (-23° C to 54° C)
LM79 DATA					L70 [DATA
TEKA LED #	LUMENS (Delivered)	сст	INPUT WATTS (Typ.)	CRI (Typ.)	Minim	um Rated Life (hrs.) - 70% of initial lumens (L70
390	152	2700	10	90		50,000
391	203	3000	10	80		50.000

General information Luminaire characteristics:

Power input: 12 to 22.1W

Lumens: 1370 to 1960 lm (delivered) Luminaire efficacy: 85 to 124 lm/W Source: White LED 3000K

Lumen maintenance: >80% of initial lumens at 100 000 hours (L80). LM-80 (LED) / LM-79 tested. Optics: Street optic, IESNA optics type II or III with comfort optic for reduced glare. Adjustable +45°/-60° tilt and 337° pan.


Body: Die-cast aluminum optical assembly and frame. Sodium-calcium tempered sealing glass, sealed at the factory. Stainless steel fastening components and hardware. Supplied with an aluminum mounting plate.

Electrical: Universal high efficiency electronic power supply, rated 50 000 H. 120V-277V. Mounting: Wall arm, wall surface or ground spike.


Finish: Gray (RAL9007) Weight: 4.9lbs (2.2kg). Warranty: 5 year limited warranty. Certification: cULus listed for wet location.

Ratings: IP66, IK09.

TYPE: X-5

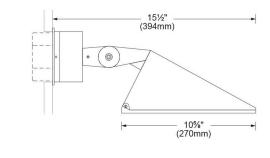

SIDE VIEW

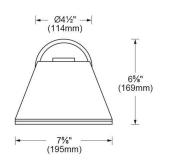

FRONT VIEW


iGuzzini


9320 Boul. St-Laurent, suite 100, Montréal (Québec) Canada H2N 1N7 P.: 514.523.1339 F.: 514.525.6107 www.iguzzini-na.com



SCREENED WALL MOUNT (SWM)

TEKA

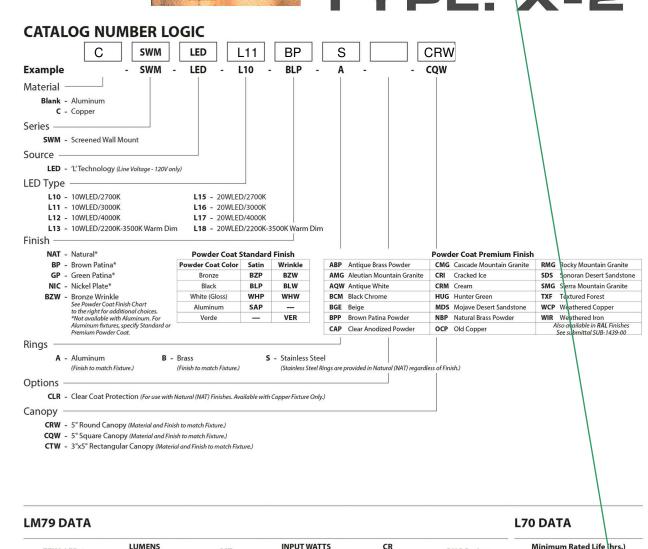

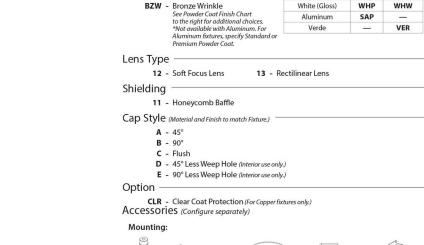

CATALOG NUMBER LOGIC

- 3", 6", 12", 18", 24", 30"

LED - 'e'Technology with Integral Dimming Driver (See Specifications for Dimming)

Adjust-e-Lume® Output Intensity (Choose factory Setting) —

A9 (Standard), A8, A7, A6, A5, A4, A3, A2, A1

e66 - 8WLED/4000K

e74 - 8WLED/Amber

MFL - Medium Flood

Powder Coat Standard Finish

Powder Coat Color Satin Wrinkle

Bronze BZP BZW
Black BLP BLW

WFL - Wide Flood

Material -

Blank - Aluminum

C - Copper

e64 - 8WLED/2700K

NSP - Narrow Spot

GP - Green Patina*

NIC - Nickel Plate*

SP - Spot

e65 - 8WLED/3000K

must be fully shielded. show on site plan. labeled as down light, not shown as so.

70% of initial lumens L70



TEKA MINI-MICRO™ **RECESSED DOWNLIGHT™** TYPE: X-6

Bronze BZP BZW Black BLP BLW White (Gloss) WHP WHW Aluminum SAP — Verde — VER Verde — VER Volished POL Mitique™ MIT AMG Aleutian Mountain Granite CRI Cracked Ice SDS Sonoran Desert San AQW Antique White CRM Cream SMG Sierra Mountain Gra AQW Antique White CRM Cream SMG Sierra		A	DM	LED	e10	AQW			
Blank - Aluminum B - Brass S - Stainless Steel Series DM - Mini-Micro™ Recessed Downlight™ Source LED - 'e' Technology with Integral Driver LED Type e38 - 3WLED/2.7K e12 - 3WLED/Red e15 - 3WLED/Blue e15 - 3WLED/Amber e10 - 3WLED/3K e13 - 3WLED/Green e15 - 3WLED/Amber e11 - 3WLED/4K Optics* SP - Spot (Green Indicator) FL - Flood (Blue Indicator) Finish Aluminum Finish Premium Finish Machined MAC Polished PoL Mittque™ MIT Stainless Finish White (Gloss) WHP WHW Aluminum SAP — Verde — VER White (Gloss) WHP WHW Aluminum SAP — Verde — VER White (Gloss) Brushed Brushed BRU Brushed BPD Brown Patina Powder NBP Natural Brass Powder Wilk Weathered Copper Section Wilk Weathered Copper Section Wilk Weathered Copper Section Wilk Weathered Sub-Histolic BRU Section Wilk Sub-Histolic BRU Section Wilk Sub-Histolic BRU Section Wilk Sub-Histolic Brushed Section Wilk Weathered Copper Section Wilk Sub-Histolic Brushed Section Wilk Su	Example	: S	- DM	- LED -	e10 -	SP - MAC - 13	- 1	1	
DM - Mini-Micro™ Recessed Downlight™ LED Type e38 - 3WLED/27K e12 - 3WLED/Red e15 - 3WLED/Blue e15 - 3WLED/Blue e15 - 3WLED/Blue e15 - 3WLED/Amber e15 - 3WLED/Blue e15 - 3	Blank - Alumi B - Brass	num							
LED Type e38 - 3WLED/2.7K e12 - 3WLED/Red e15 - 3WLED/Amber e10 - 3WLED/3K e13 - 3WLED/Green e15 - 3WLED/Amber e11 - 3WLED/AK Optics* SP - Spot (Green Indicator) FL - Flood (Blue Indicator) FL - Flood (Blue Indicator) FL - Flood (Blue Indicator) Fl - Spot (Green Indicator) FL - Flood (Blue Indicator) Fl - Spot (Green Indicator) FL - Flood (Blue Indicator) FL - Flood (Blue Indicator) Fl - Spot (Green Indicator) FL - Flood (Blue Indicator) Fl - Spot (Green Indicator) FL - Flood (Blue Indicator) Fl - Spot (Green Indicator) FL - Flood (Blue Indicator) Fl - Spot (Green Indicator) FL - Flood (Blue Indicator) Fl - Spot (Green Indicator) FL - Flood (Blue Indicator) Fl - Spot (Green Indicator) Fl -			essed Downli	ght™					
LED Type e38 - 3WLED/2.7K e12 - 3WLED/Red e15 - 3WLED/Blue e15 - 3WLED/Amber Finish Aluminum Finish Premium Finish Aluminum Finish Brass Finish Machined MAC Polished POL Black BLP BLW White (Gloss) WHP WHW Aluminum SAP — Verde — VER White (Gloss) WHP WHW Aluminum SAP — Verde — VER White (Gloss) WHP WHW Aluminum SAP — Verde — VER White (Gloss) WHP WHW Aluminum SAP — VER BRUS Finish Machined MAC Polished POL Brushed BRU BRUS BRUS BRUS BRUS BRUS BRUS BRUS BRUS			ith Intogral C	Privor					
e38 - 3WLED/2.7K e12 - 3WLED/Red e13 - 3WLED/Red e15 - 3WLED/Blue e15 - 3WLED/Amber e11 - 3WLED/3K e13 - 3WLED/AK Optics* SP - Spot (Green Indicator) FL - Flood (Blue Indicator) FL - Flood (Blue Indicator) Finish Aluminum Finish Brass Finish Machined MAC Pollshed POL Mitique™ MIT Black BLP BLW White (Gloss) WHP WHW Aluminum SAP - Verde			itir integral L	лічеі					
Optics* SP - Spot (Green Indicator) FL - Flood (Blue Indicator) FL - Flood (Blue Indicator) FINISh Aluminum Finish Brass Finish Machined MAC Polished POL Mitique™ MIT Aluminum SAP Aluminum SAP Aluminum SAP Verde G- Verde G- VER Machined MAC Polished POL BRU BRU BRU BRU BRU BRU BRU BROW Patina Powder NBP Natural Brass Powder War Weathered Copper Mass Powder War Weathered Iron Also available in RAL Finish See submittal SUB-1439-04									
Aluminum Finish Brass Finish Premium Finish Powder Coat Color Satin Wrinkle Machined MAC ABP Antique Brass Powder CMG Cascade Mountain Granite RMG Rocky Mountain Granite RMG Aleutian Mountain Granite CRI Cracked Ice SDS Sonoran Desert San Aluminum SAP HM Wachined MAC BCM Black Chrome HUG Hunter Green TXF Textured Forest Aluminum SAP Polished POL BRU BRU BBP Brown Patina Powder NBP Natural Brass Powder We Weathered Iron Verde TYE Textured Forest BPP Brown Patina Powder NBP Natural Brass Powder Will Weathered Iron	e10 - 3WLED	D/3K D/4K	e13	- 3WLED/Gree	n				
Bronze BZP BZW Black BLP White (Gloss) WHP WHW Stainless Finish Aluminum SAP Verde Werde Werde Werde Werde BZP BZW Mitique™ MIT AMM Aleutian Mountain Granite AQW Antique White CRM Cream SMG Sierra Mountain Gran SMG Sierra Mountain Gran SMG Sierra Mountain Gran MAC Polished MAC Polished POL Brushed BRU BRUSH B	e10 - 3WLEC e11 - 3WLEC Optics* SP - Spot (FL - Flood	D/3K D/4K Green Indica	e13	- 3WLED/Gree	n				
Black BLP BLW White (Gloss) WHP WHW Aluminum SAP — Verde — VER Wildique™ MIT AQW Antique White CRM Cream SMG Sierra Mountain Grainte CRM BCM Black Chrome HUG Hunter Green TXF Textured Forest MDS Mojave Desert Sandstone WCP Weathered Copper Welthered Copper CAP Clear Anodized Powder OCP Old Copper See submittal SUB-1439-04 ABO available in RAL Finish See submittal SUB-1439-04	e10 - 3WLEC e11 - 3WLEC Optics*	D/3K D/4K Green Indica (Blue Indicat	e13	- 3WLED/Gree	n		P	remium Finish	
Black BLP BLW White (Gloss) WHP WHW Aluminum SAP — Verde — VER Stainless Finish Machined MAC Polished POL Brushed BRU Brushed BRU Brushed BRU Brushed BRU Brushed BRU CAP Clear Anodized Powder OCP Old Copper CAP Clear Anodized Powder OCP Old Copper Active CRM Cream SMG Sierra Mountain Gra MC Hunter Green TXF Textured Forest MDS Mojave Desert Sandstone WCP Weathered Copper Will Weathered Iron Also available in RAL Finish See submittal SUB-1439-04	e10 - 3WLEC e11 - 3WLEC Optics* SP - Spot (FL - Flood Finish	D/3K D/4K Green Indica (Blue Indicat m Finish	e13	- 3WLED/Gree	n inish	e15 - 3WLED/Amber			RMG Rocky Mountain Granite
Winte (closs) WHP WHW Aluminum SAP — Machined MAC Polished POL Brushed BRW Black Chrome HUG Hunter Green TXF lextured Forest Machined MAC Polished POL Brushed BRU Brushed BRU Brushed BRU	e10 - 3WLEC e11 - 3WLEC Optics* SP - Spot (FL - Flood Finish Aluminu Powder Coat Color	D/3K D/4K Green Indicat (Blue Indicat m Finish Satin	tor)	Brass F	inish MAC	e15 - 3WLED/Amber ABP Antique Brass Powder	CMG	Cascade Mountain Granite	,
Aluminum SAP — Polished POL Brushed BRU Interior use only. Verde — VER Polished POL BRU BRU SPOW POLISHED POL BRU Interior use only. CAP Clear Anodized Powder OCP Old Copper Also available in RAL Finish See submitted SUB-1439-00.	e10 - 3WLEC e11 - 3WLEC Optics* SP - Spot (FL - Flood Finish Aluminu Powder Coat Color Bronze	D/3K D/4K Green Indica (Blue Indicat m Finish Satin BZP	tor) cor) Wrinkle BZW	Brass F Machined Polished	Finish MAC POL	ABP Antique Brass Powder AMG Aleutian Mountain Granite	CMG	Cascade Mountain Granite Cracked Ice	· ·
Verde — VER BRU BRU Brushed BRU CAP Clear Anodized Powder OCP Old Copper Also available in RAL Finish See submittal SUB-1439-04	e10 - 3WLEC e11 - 3WLEC Optics* SP - Spot (FL - Flood Finish Aluminu Powder Coat Color Bronze Black	D/3K D/4K Green Indica (Blue Indicat m Finish Satin BZP BLP	tor) or) Wrinkle BZW BLW	Brass F Machined Polished Mitique™	inish MAC POL MIT	ABP Antique Brass Powder AMG Aleutian Mountain Granite AQW Antique White	CMG CRI CRM	Cascade Mountain Granite Cracked Ice Cream	SDS Sonoran Desert Sandstor SMG Sierra Mountain Granite
CAP Clear Anodized Powder OCP Old Copper Ako available in RAL Finish See submittal SUB-1439-00	e10 - 3WLEC e11 - 3WLEC Optics* SP - Spot (FL - Flood Finish Aluminu Powder Coat Color Bronze Black White (Gloss)	D/3K D/4K Green Indica (Blue Indicat m Finish Satin BZP BLP WHP	tor) Wrinkle BZW BLW WHW	Brass F Machined Polished Mitique [™] Stainles: Machined	inish MAC POL MIT S Finish MAC	ABP Antique Brass Powder AMG Aleutian Mountain Granite AQW Antique White BCM Black Chrome	CMG CRI CRM HUG	Cascade Mountain Granite Cracked Ice Cream Hunter Green	SDS Sonoran Desert Sandsto SMG Sierra Mountain Granite TXF Textured Forest
	e10 - 3WLEC e11 - 3WLEC Optics* SP - Spot (FL - Flood Finish Aluminu Powder Coat Color Bronze Black White (Gloss) Aluminum)/3K //4K Green Indica (Blue Indicat m Finish Satin BZP BLP WHP SAP	tor) Wrinkle BZW BLW WHW	Brass F Machined Polished Mittique ^{ns} Stainles: Machined Polished	Finish MAC POL MIT FINISH MAC POL BRU	ABP Antique Brass Powder AMG Aleutian Mountain Granite AQW Antique White BCM Black Chrome BGE Beige	CMG CRI CRM HUG MDS	Cascade Mountain Granite Cracked Ice Cream Hunter Green Mojave Desert Sandstone	SDS Sonoran Desert Sandsto SMG Sierra Mountain Granite TXF Textured Forest WCP Weathered Copper
Long Lyno	e10 - 3WLEC e11 - 3WLEC Optics* SP - Spot (FL - Flood Finish Aluminu Powder Coat Color Bronze Black White (Gloss) Aluminum)/3K //4K Green Indica (Blue Indicat m Finish Satin BZP BLP WHP SAP	tor) Wrinkle BZW BLW WHW	Brass F Machined Polished Mittique ^{ns} Stainles: Machined Polished	Finish MAC POL MIT FINISH MAC POL BRU	ABP Antique Brass Powder AMG Aleutian Mountain Granite AQW Antique White BCM Black Chrome BGE Beige BPP Brown Patina Powder	CMG CRI CRM HUG MDS NBP	Cascade Mountain Granite Cracked Ice Cream Hunter Green Mojave Desert Sandstone Natural Brass Powder	SDS Sonoran Desert Sandsto SMG Sierra Mountain Granite TXF Textured Forest WCP Weathered Copper WIR Weathered Iron Also available in RAL Finishes
12 - Soft Focus Lens 13 - Rectilinear Lens	e10 - 3WLEC e11 - 3WLEC Optics* SP - Spot (FL - Flood Finish Aluminu Powder Coat Color Bronze Black White (Gloss) Aluminum	0/3K 0/4K Green Indicat (Blue Indicat m Finish Satin BZP BLP WHP SAP	tor) Wrinkle BZW BLW WHW	Brass F Machined Polished Mittique ^{ns} Stainles: Machined Polished	Finish MAC POL MIT FINISH MAC POL BRU	ABP Antique Brass Powder AMG Aleutian Mountain Granite AQW Antique White BCM Black Chrome BGE Beige BPP Brown Patina Powder	CMG CRI CRM HUG MDS NBP	Cascade Mountain Granite Cracked Ice Cream Hunter Green Mojave Desert Sandstone Natural Brass Powder	SDS Sonoran Desert Sandsto SMG Sierra Mountain Granite TXF Textured Forest WCP Weathered Copper WIR Weathered Iron

M79 DA	ΓΑ			L70 DATA	*OPTICAL DA	ATA	
BK No.	CCT (Typ.)	Input Watts (Typ.)	CRI	Minimum Rated Life (hrs.) 70% of initial lumens (L ₇₀)	Beam Type	Angle	Visual Indicator
e38	2700K	3.0	90	50,000	Spot	16°	Green Dot
e10	3100K	3.0	90	50,000	Flood	33°	Blue Dot
e11	4100K	3.0	75	50,000			
e12	Red (627nm)	2.8	~	50,000			
e13	Green (530nm)	3.0	~	50,000			
e14	Blue (470nm)	3.0	~	50,000			
e15	Amber (590nm)	2.8	~	50,000			





PINNACLE FLOODLIGHT (PNF)

TYPE: X-3

Powder Coat Premium Finish

SMG Sierra Mountain Granite

TXF Textured Forest

MDS Mojave Desert Sandstone WCP Weathered Copper

CRM Cream


HUG Hunter Green

PNF 6" LED e65 MFL A9 BP 12 11 C - PNF - 18" - LED - e64 - NSP - A9 - BZW - 12 - 11 - A - POWER CANOPY

AMG Aleutian Mountain Granite CRI Cracked Ice

AQW Antique White

BCM Black Chrome

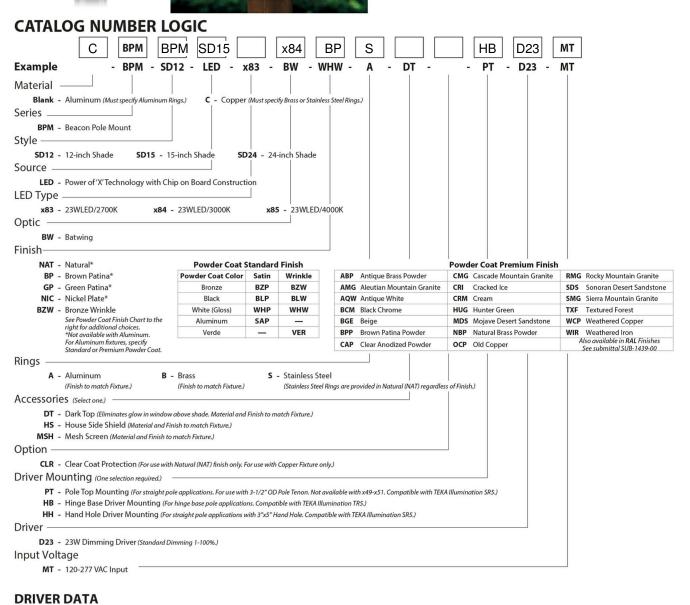


D/11/1								
AC Input Range	Frequency Hz	Power Factor At Full Load (Efficiency)	THD	InRush Current	Operating Current	Operation Ambient Temperature	Dimmer Type	Din Ra
D23 120-277Vac 50/60 Hz		>.90	≤20%	30mA ² s@277V	700mA	(-30° C to 50° C)	0-10V	1-1
ATA				ı	.70 DAT	1		
# LUMENS (Delivered)	сст	INPUT WATTS (Typ.)	CI	RI (Typ.)	Minimum Ra	ted Life (hrs.) - 70% of initial lumens	(L70)	
1725	2700	23		80		50,000		
1889	3000	23		80		50,000		
1913	4000	23		80		50,000		
	AC Input Range 120-277Vac ATA # LUMENS (Delivered) 1725 1889	AC Input Range	# LUMENS (Delivered) CCT INPUT WATTS (Typ.) 1725 2700 23 1889 3000 23	AC Input Range	AC Input Range	AC Input Range	AC Input Range	AC Input Range



CLASSIC HIGH LIGHT PATH (HLP-C) TEKA

TYPE: X-4

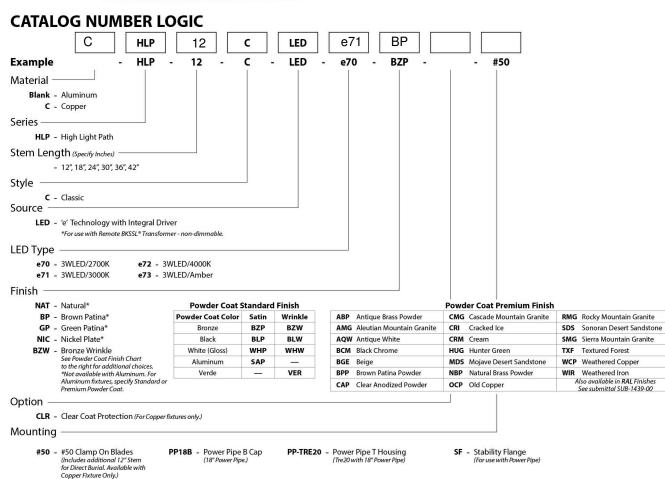

DRIVER DA	NTΛ Inpu	ut Volts	InRush Current	O	perating Current	Operation Ambient Temperature
DRIVER DA	12VAC/	OC 50/60Hz	12A Max		700mA	-22°F to 194°F (-30°C to 90°C)
LM79 DAT	A				L70 DATA	
TEKA LED #	DELIVERED LUMENS	ССТ	INPUT WATTS (Typ.)	CRI (Typ.)	Minimum Rated	d Life (hrs.) - 70% of initial lumens (L70)
e70	82	2700	3	80		50,000
e71	95	3000	3	80		50,000
e72	104	4000	3	80		50,000
e73	-	Amber (590nm)	3	-		50,000

OTTSDAL

SCOTTSDAL

DESIGNERS OF PROGRESSIVE ARCHITECTURE 7272 e indian school rd ste 214 scottsdale, arizona 85251 telephone 480 941 4222 www.dpaarchitects.com


REVISION INFORMATION #: Description: drawn by:

project no.: 18024 11/13/18 AS502-

> 24-ZN-2018 11/14/18

EXTERIOR LIGHTING CUT-SHEETS

CITY OF SCOTTSDALE REZONING/DR DEVELOPMENT SUBMITTAL PRE-APP CASE #486 - PA - 2018

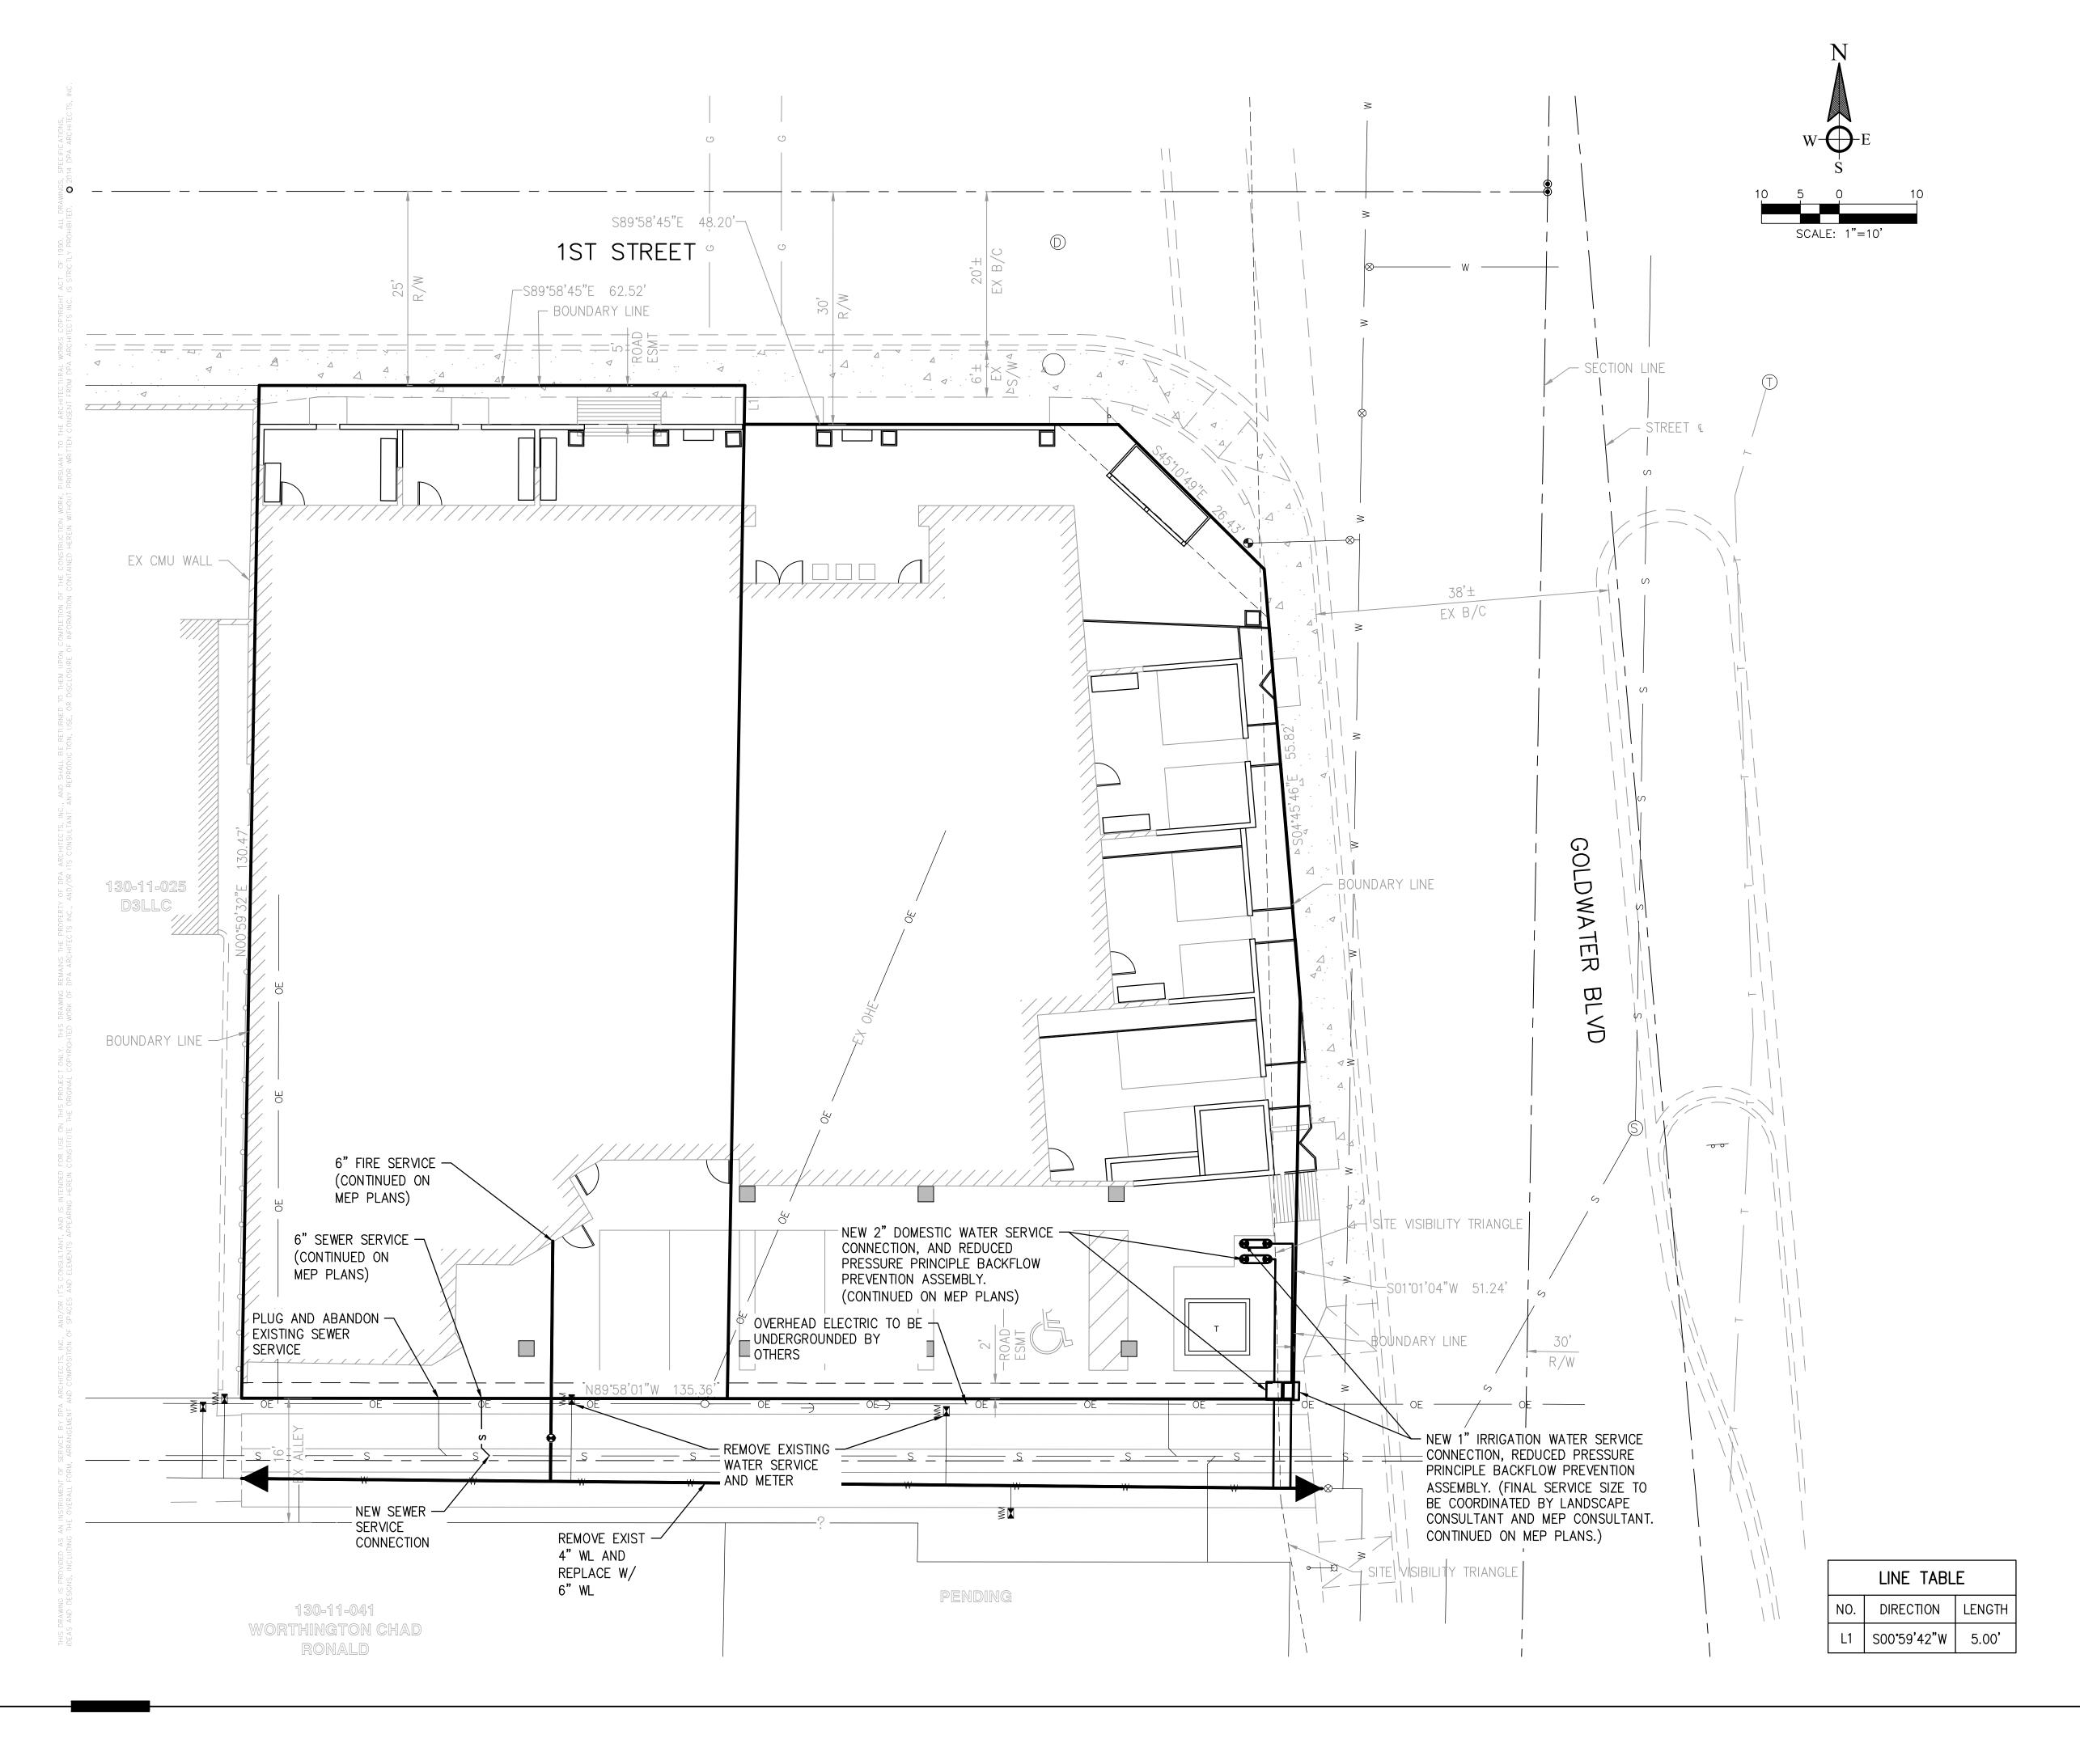


LEGEND

TRANSFORMER CONCRETE MASONRY UNIT TRANS RIGHT-OF-WAY OHE/OE OVERHEAD ELECTRIC
CL CENTERLINE
EX EXISTING
ESMT EASEMENT
S SEWER

WATER

59959 CLAYTON L. NEILSEN

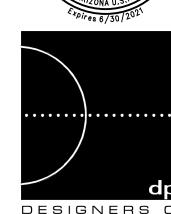


DESIGNERS OF PROGRESSIVE ARCHITECTURE 7272 e indian school rd ste 214 scottsdale, arizona 85251 telephone 480 941 4222 www.dpaarchitects.com

REVISION INFORMATION								
#:	Description:	Date:						

drawn by:	DAB/NAM
project no.:	1054.02
date:	11/12/2018
·	

PRELIMINARY UTILITY PLAN



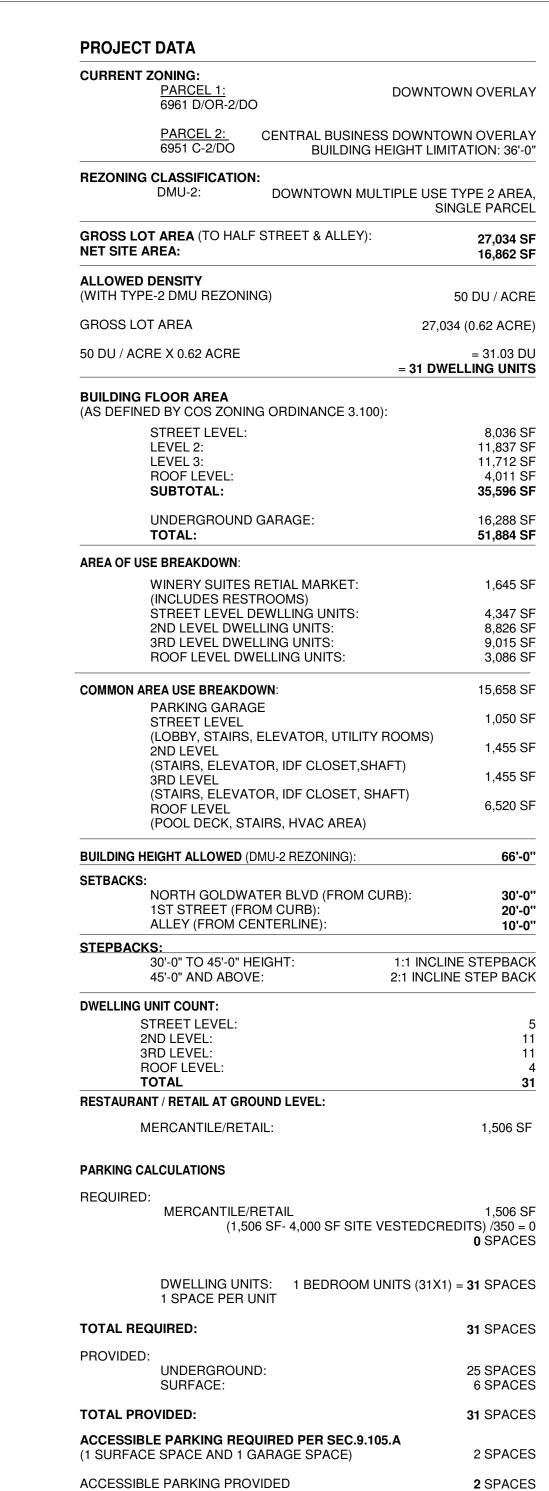

Demonstrate the location of the Fire Department Connection (Fire Ord.



(1 SURFACE SPACE AND 1 GARAGE SPACE)

SITE PLAN

CITY OF SCOTTSDALE
REZONING/DR DEVELOPMENT SUBMITTAL
PRE-APP CASE #486 - PA - 2018

dpa

DESIGNERS OF
PROGRESSIVE
ARCHITECTURE
7272 e indian school rd ste 214
scottsdale, arizona 85251
telephone 480 941 4222
www.dpaarchitects.com

REVISION INFORMATION
#: Description: Date:

drawn by:

project no.:


OTTSDAL

PLOT DATE: 11/13/2018 4:13:30 PM

24-ZN-2018 11/14/18

AS100-


11/13/18

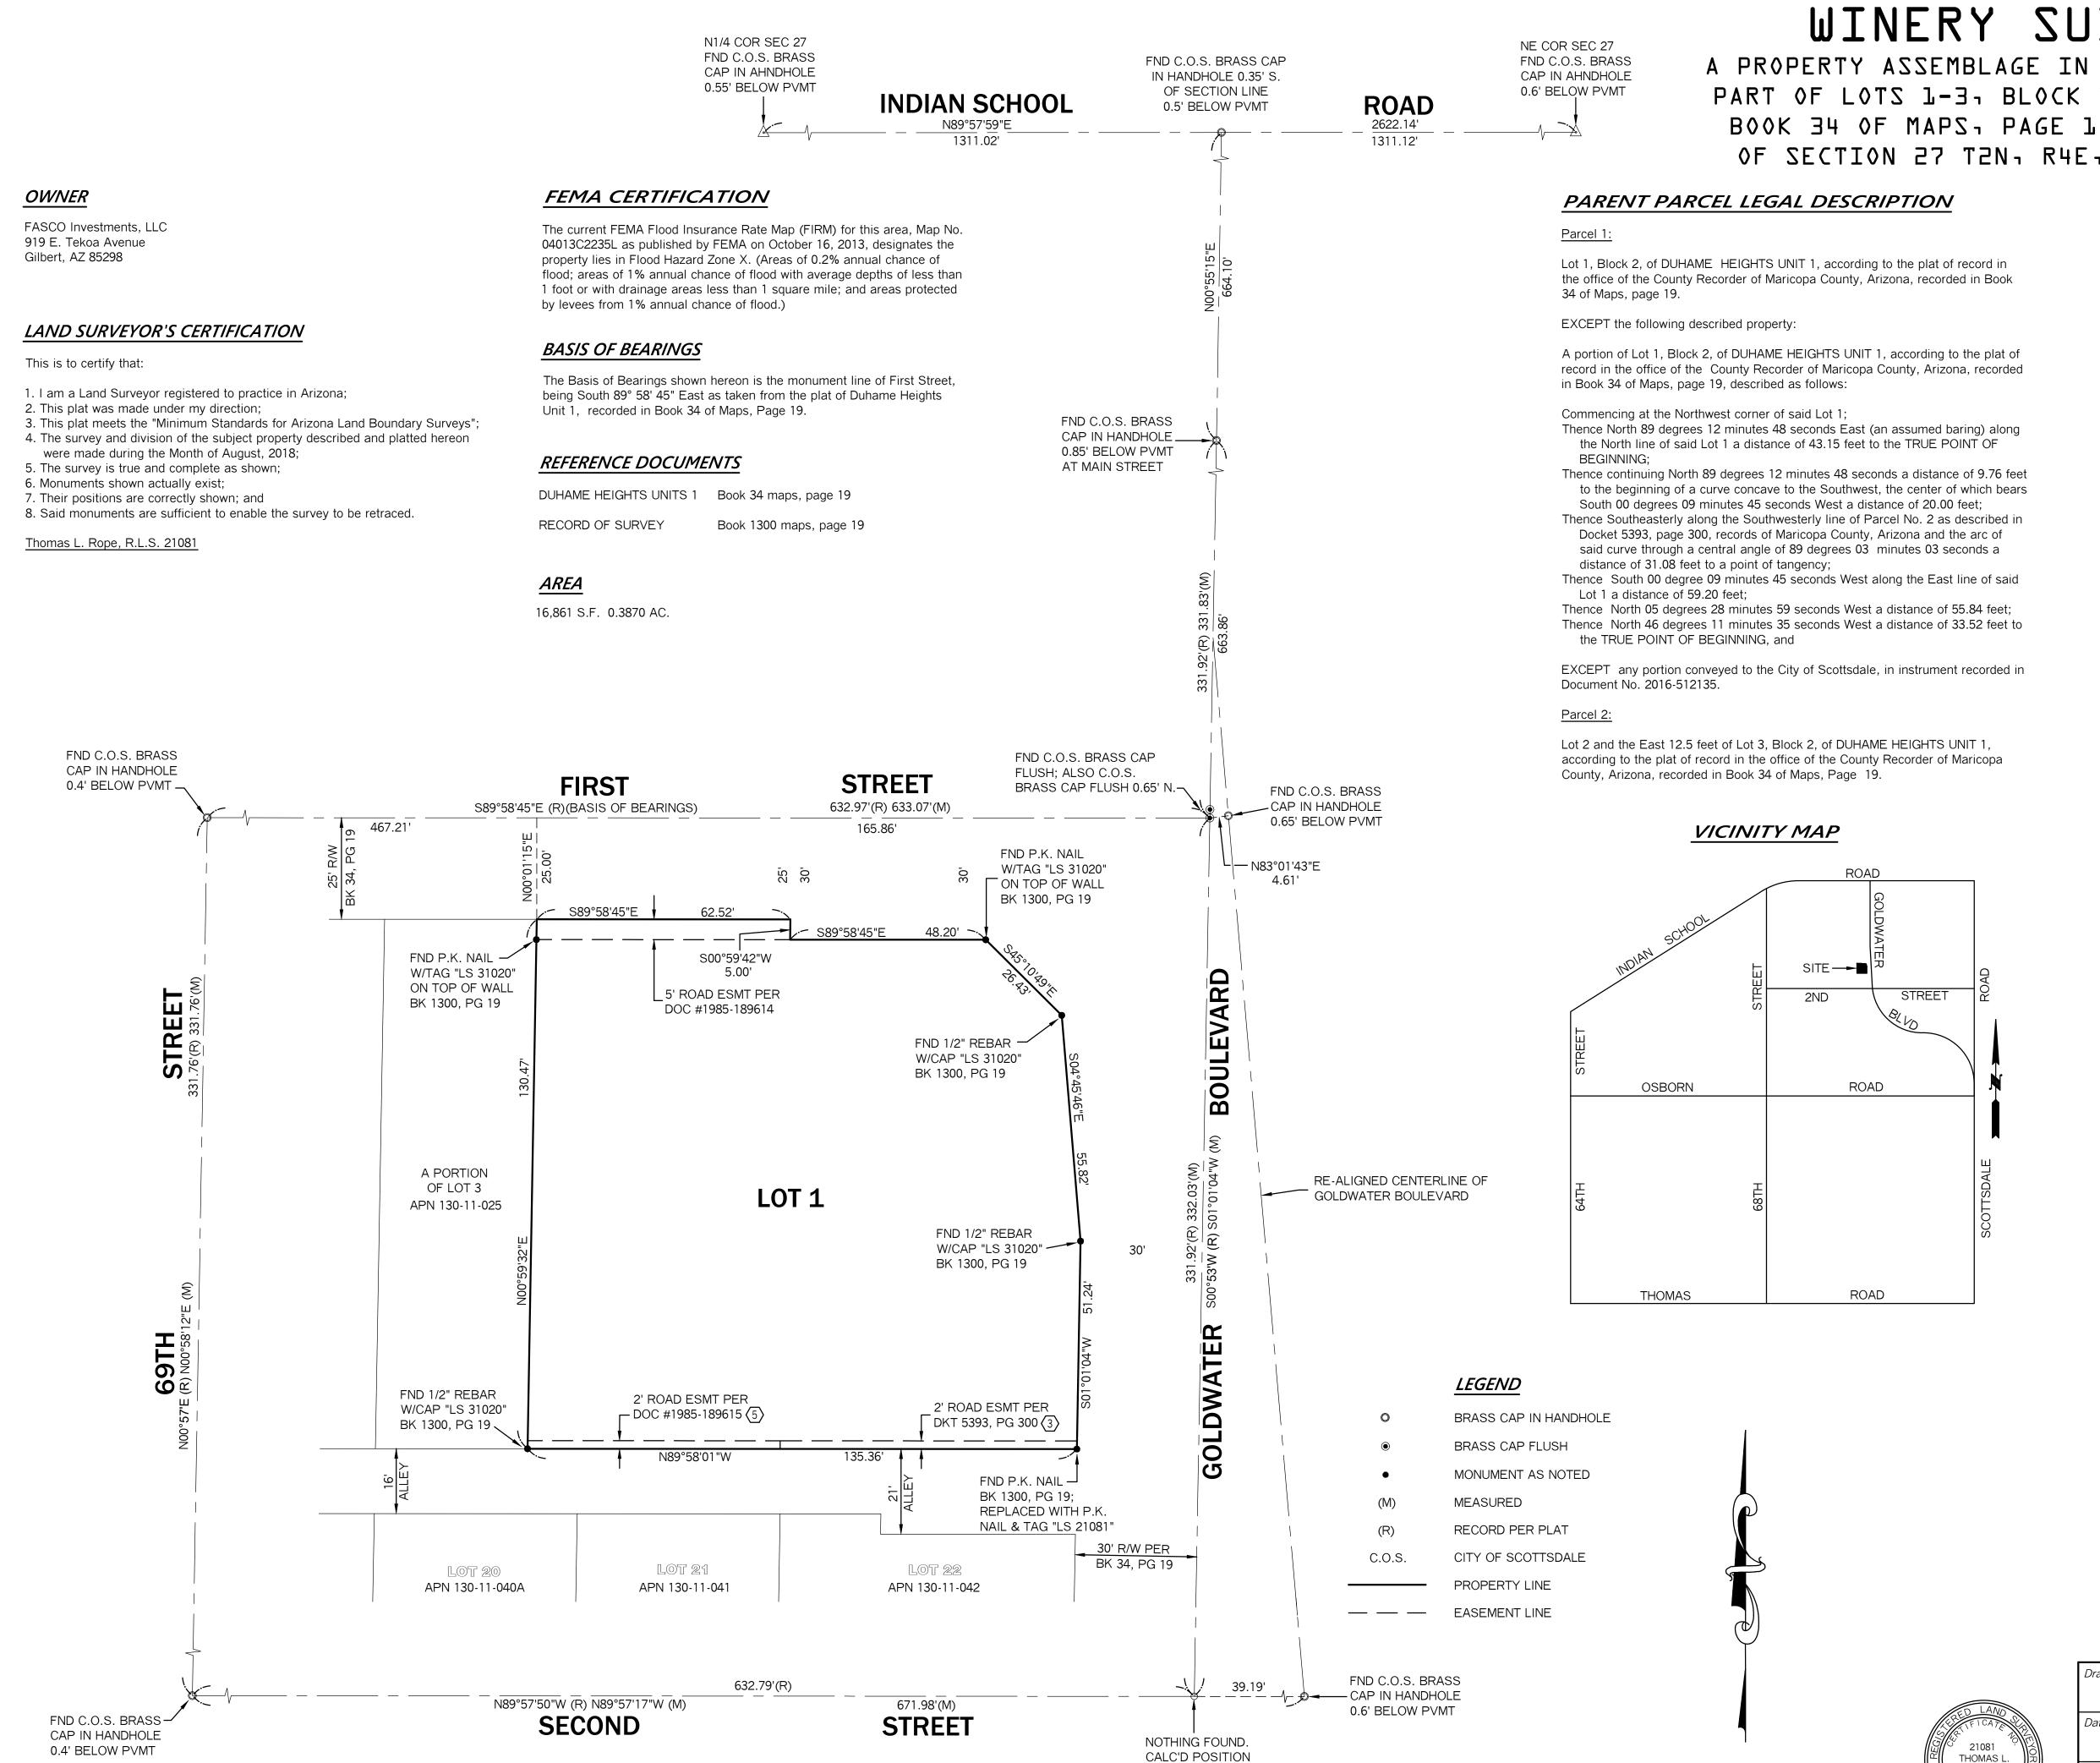

WINERY SUITES OF SCOTTSDALE

A PROPERTY ASSEMBLAGE IN THE CITY OF SCOTTSDALE, ARIZONA, BEING A PART OF LOTS 1-3, BLOCK 2, DUHAME HEIGHTS UNIT 1, AS RECORDED IN BOOK 34 OF MAPS, PAGE 19 AND SITUATED IN THE NORTHEAST QUARTER OF SECTION 27 T2N, R4E, G.& S.R.B.M, MARICOPA COUNTY, ARIZONA

USING RECORD DISTANCE FROM 69TH STREET

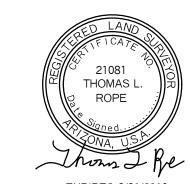

(IN FEET)

1 inch = 20 ft.

EXPIRES 3/31/2019

DEDICATION

STATE OF ARIZONA COUNTY OF MARICOPA)

Know All Men By These Presents:

Fassco Investments, LLC, an Arizona limited liability company, owner, has assembled Lots 1 and 2 and a portion of Lot 3, Block 2 of "Duhame Heights Unit 1", a subdivision recorded in Book 34 of Maps, page 19 and being a portion of the Northwest guarter of Section 27, Township 2 North, Range 4 East, Gila & Salt River Base & Meridian, Maricopa County, Arizona as shown and platted hereon and hereby publishes this plat as and for the plat of a property assemblage, and hereby declares that said plat sets forth the location and gives the dimensions of the lots, streets and easements constituting same, and that the lot and streets shall be known by the number or name given each respectively on said plat. Fassco Investments, LLC, as owner, hereby dedicates to the public for use as such, the streets and easements shown on said plat and included in the above described premises.

In witness whereof:

Fassco Investments, LLC, an Arizona limited liability company, as legal owner, has hereunto affixed its signature this _____day of ______, 2018.

Ross Fasano, Managing Member

ACKNOWLEDGMENT

STATE OF ARIZONA COUNTY OF MARICOPA)

On this, the _____day of ____ , 2018, before me the undersigned, appeared and acknowledged himself to be Ross Fasano, the Managing Member of Fassco Investments, LLC, an Arizona Limited liability company, and that he, as such officer, being duly authorized to do so, executed the foregoing instrument for the purposes therein contained by signing in the name of the company by himself as Managing Member.

In witness whereof:

I hereunto set my hand and official seal.

Notary Public

My Commission Expires

APPROVALS

This plat has been reviewed for compliance with the City of Scottsdale's Design Standards and Policy Manual Specifications.

Chief Development Officer


This subdivision has been reviewed for compliance with development standards of the City of Scottsdale. Staff Approval Cases No. 7-DR-2016, and all case related stipulations.


Plat Coordinator

NOTES

- 1. This plat is located within the City of Scottsdale Water Service Area and has been designated as having an assured water supply.
- 2. Construction within the public utility easements, except by public agencies and utility companies, shall be limited to wood, wire or removable section-type fencing and must be in constructed in comformance with applicable CC&R's and
- design guidelines. 3. Electric lines are to be cosntructed underground as required by Arizona Corporation Commission General Order U-48.
- 4. All new or relocated utilities will be constructed underground as required by the
- Arizona Corporation Commission general Order U-28.
- 5. Parcel 1 is zoned S-R and Parcel 2 is zoned C-2 under the City of Scottsdale Zoning Ordinance.
- 6. Affidavits of Correction or Amendment type letters concerning this plat are not valid. There will be no revisions to this plat without Plat Coordinators approval.

WINERY SUITES OF SCOTTSDALE

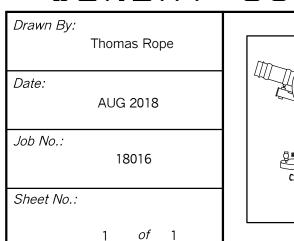

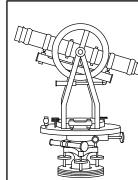

Land Survey Services PLC **Thomas L. Rope, R.L.S.** 3160 North 302nd Lane Buckeye, AZ 85396-3196 Phone No. 602.703.7010

LandSurveyServices@cox.net

LEGAL DESCRIPTION

LOT COMBINATION

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Containing 16,862 sq. ft. or 0.3871 acres


21081 THOMAS L. ROPE 8-10-18

Expires 3-31-2019

Job No. 18016

EXHIBIT

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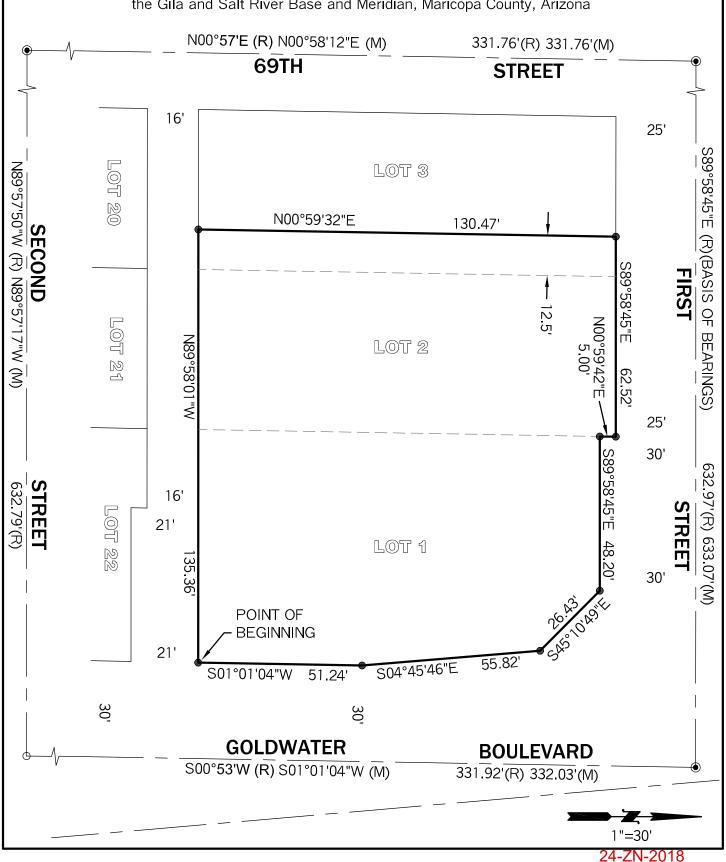
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WINERY SUITES OF SCOTTSDALE N1/4 COR SEC 27 NE COR SEC 27 FND C.O.S. BRASS FND C.O.S. BRASS CAP FND C.O.S. BRASS A PROPERTY ASSEMBLAGE IN THE CITY OF SCOTTSDALE, ARIZONA, BEING A CAP IN AHNDHOLE IN HANDHOLE 0.35' S. CAP IN AHNDHOLE 0.55' BELOW PVMT PART OF LOTS 1-3, BLOCK 2, DUHAME HEIGHTS UNIT 1, AS RECORDED IN OF SECTION LINE 0.6' BELOW PVMT INDIAN SCHOOL **ROAD** 0.5' BELOW PVMT BOOK 34 OF MAPS, PAGE 19 AND SITUATED IN THE NORTHEAST QUARTER 2622.14' 1311.12' OF SECTION 27 T2N, R4E, G.& S.R.B.M, MARICOPA COUNTY, ARIZONA FEMA CERTIFICATION **OWNER** PARENT PARCEL LEGAL DESCRIPTION FASCO Investments, LLC The current FEMA Flood Insurance Rate Map (FIRM) for this area, Map No. Parcel 1: 919 E. Tekoa Avenue 04013C2235L as published by FEMA on October 16, 2013, designates the Gilbert, AZ 85298 property lies in Flood Hazard Zone X. (Areas of 0.2% annual chance of Lot 1. Block 2, of DUHAME HEIGHTS UNIT 1, according to the plat of record in flood; areas of 1% annual chance of flood with average depths of less than the office of the County Recorder of Maricopa County, Arizona, recorded in Book 1 foot or with drainage areas less than 1 square mile; and areas protected 34 of Maps, page 19. by levees from 1% annual chance of flood.) EXCEPT the following described property: LAND SURVEYOR'S CERTIFICATION **BASIS OF BEARINGS** PLATTING TO CONFORM TO CITY STANDARDS A portion of Lot 1, Block 2, of DUHAME HEIGHTS UNIT 1, according to the plat of This is to certify that: record in the office of the County Recorder of Maricopa County, Arizona, recorded The Basis of Bearings shown hereon is the monument line of First Street, in Book 34 of Maps, page 19, described as follows: 1. I am a Land Surveyor registered to practice in Arizona; being South 89° 58' 45" East as taken from the plat of Duhame Heights 2. This plat was made under my direction; Unit 1, recorded in Book 34 of Maps, Page 19. Commencing at the Northwest corner of said Lot 1: FND C.O.S. BRASS 3. This plat meets the "Minimum Standards for Arizona Land Boundary Surveys"; Thence North 89 degrees 12 minutes 48 seconds East (an assumed baring) along CAP IN HANDHOLE 4. The survey and division of the subject property described and platted hereon the North line of said Lot 1 a distance of 43.15 feet to the TRUE POINT OF 0.85' BELOW PVMT were made during the Month of August, 2018; REFERENCE DOCUMENTS 5. The survey is true and complete as shown: AT MAIN STREET Thence continuing North 89 degrees 12 minutes 48 seconds a distance of 9.76 feet 6. Monuments shown actually exist; to the beginning of a curve concave to the Southwest, the center of which bears DUHAME HEIGHTS UNITS 1 Book 34 maps, page 19 7. Their positions are correctly shown; and South 00 degrees 09 minutes 45 seconds West a distance of 20.00 feet; 8. Said monuments are sufficient to enable the survey to be retraced. Thence Southeasterly along the Southwesterly line of Parcel No. 2 as described in Book 1300 maps, page 19 RECORD OF SURVEY Docket 5393, page 300, records of Maricopa County, Arizona and the arc of Thomas L. Rope, R.L.S. 21081 said curve through a central angle of 89 degrees 03 minutes 03 seconds a distance of 31.08 feet to a point of tangency; Thence South 00 degree 09 minutes 45 seconds West along the East line of said AREA Lot 1 a distance of 59.20 feet: Thence North 05 degrees 28 minutes 59 seconds West a distance of 55.84 feet; 16,861 S.F. 0.3870 AC. Thence North 46 degrees 11 minutes 35 seconds West a distance of 33.52 feet to the TRUE POINT OF BEGINNING, and EXCEPT any portion conveyed to the City of Scottsdale, in instrument recorded in Document No. 2016-512135. Parcel 2: Lot 2 and the East 12.5 feet of Lot 3, Block 2, of DUHAME HEIGHTS UNIT 1, FND C.O.S. BRASS FND C.O.S. BRASS CAP according to the plat of record in the office of the County Recorder of Maricopa CAP IN HANDHOLE FLUSH; ALSO C.O.S. County, Arizona, recorded in Book 34 of Maps, Page 19. **STREET FIRST** 0.4' BELOW PVMT _ BRASS CAP FLUSH 0.65' N.~ FND C.O.S. BRASS 632.97'(R) 633.07'(M) _CAP IN HANDHOLE S89°58'45"E (R)(BASIS OF BEARINGS) 0.65' BELOW PVMT 165.86' VICINITY MAP FND P.K. NAIL - N83°01'43"E W/TAG "LS 31020" ROAD 4.61' ON TOP OF WALL BK 1300, PG 19 S89°58'45"E S89°58'45"E 48.20' →、 FND P.K. NAIL -S00°59'42"W W/TAG "LS 31020" ULEVARD ON TOP OF WALL **STREET**1.76'(R) 331.76'(A) _5' ROAD ESMT PER STREET 2ND BK 1300, PG 19 DOC #1985-189614 FND 1/2" REBAR -W/CAP "LS 31020" DEDICATE AS ROW BK 1300, PG 19 OSBORN ROAD HEREON A PORTION RE-ALIGNED CENTERLINE OF OF LOT 3 LOT 1 GOLDWATER BOULEVARD APN 130-11-025 FND 1/2" REBAR W/CAP "LS 31020" stipulations. BK 1300, PG 19 THOMAS ROAD **NOTES LEGEND** FND 1/2" REBAR 2' ROAD ESMT PER 2' RÒAD ESMT PER W/CAP "LS 31020" — DOC #1985-189615 ⟨5⟩ DKT 5393, PG 300 (3) BRASS CAP IN HANDHOLE BK 1300, PG 19 \ **BRASS CAP FLUSH** N89°58'01"W design guidelines. MONUMENT AS NOTED FND P.K. NAIL BK 1300, PG 19; MEASURED REPLACED WITH P.K. 4. All new or relocated utilities will be constructed underground as required by the NAIL & TAG "LS 21081" RECORD PER PLAT 30' R/W PER CITY OF SCOTTSDALE BK 34, PG 19 LOT 21 LOT 22 LOT 20 PROPERTY LINE APN 130-11-040A APN 130-11-041 APN 130-11-042 — EASEMENT LINE Drawn By: FND C.O.S. BRASS 632.79'(R) 39.19' Thomas Rope N89°57'50"W (R) N89°57'17"W (M) 671.98'(M) 0.6' BELOW PVMT **STREET** FND C.O.S. BRASS-**SECOND** CAP IN HANDHOLE AUG 2018 NOTHING FOUND. 0.4' BELOW PVMT CALC'D POSITION ΓHOMAS L. Job No.: **USING RECORD** DISTANCE FROM 18016 69TH STREET (IN FEET Ihoms I Ke

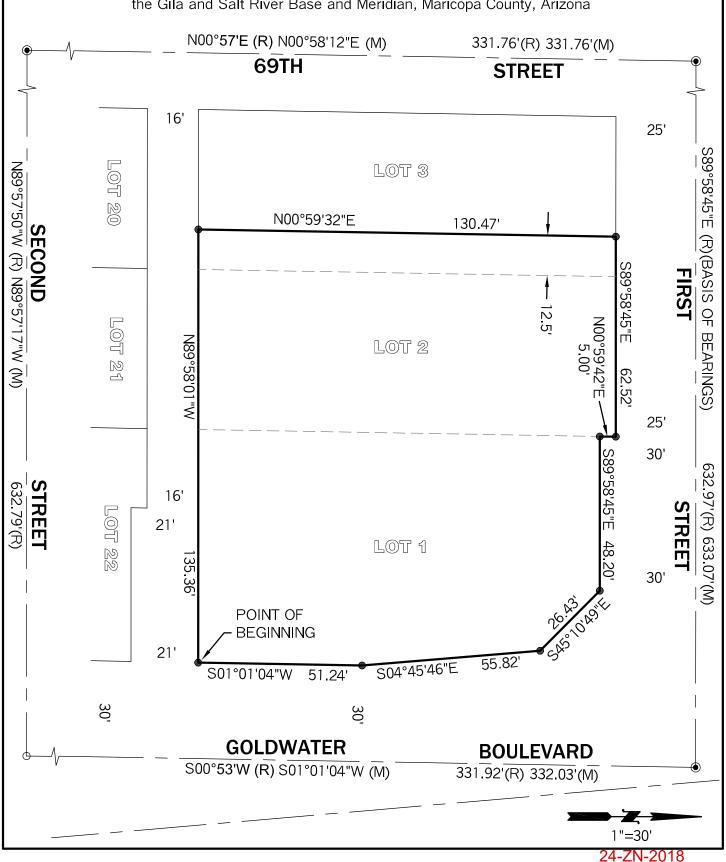DEDICATION

STATE OF ARIZONA COUNTY OF MARICOPA)

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In witness whereof:

Fassco Investments, LLC, an Arizona limited liability company, as legal owner, has hereunto affixed its signature this _____day of ______, 2018.

Ross Fasano, Managing Member

ACKNOWLEDGMENT

STATE OF ARIZONA COUNTY OF MARICOPA)

On this, the _____day of ___ , 2018, before me the undersigned, appeared and acknowledged himself to be Ross Fasano, the Managing Member of Fassco Investments, LLC, an Arizona Limited liability company, and that he, as such officer, being duly authorized to do so, executed the foregoing instrument for the purposes therein contained by signing in the name of the company by himself as Managing Member.

In witness whereof:

I hereunto set my hand and official seal.

Notary Public

My Commission Expires

APPROVALS

This plat has been reviewed for compliance with the City of Scottsdale's Design Standards and Policy Manual Specifications.


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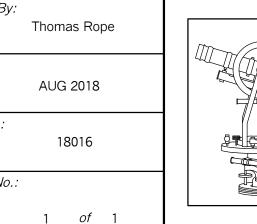
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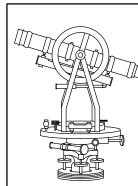
WINERY SUITES OF SCOTTSDALE



EXPIRES 3/31/2019

1 inch = 20 ft.



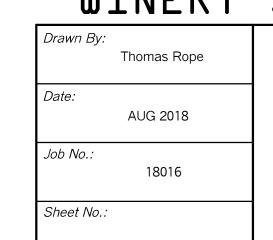

Land Survey Services PLC **Thomas L. Rope, R.L.S.** 3160 North 302nd Lane Buckeye, AZ 85396-3196 Phone No. 602.703.7010 LandSurveyServices@cox.net

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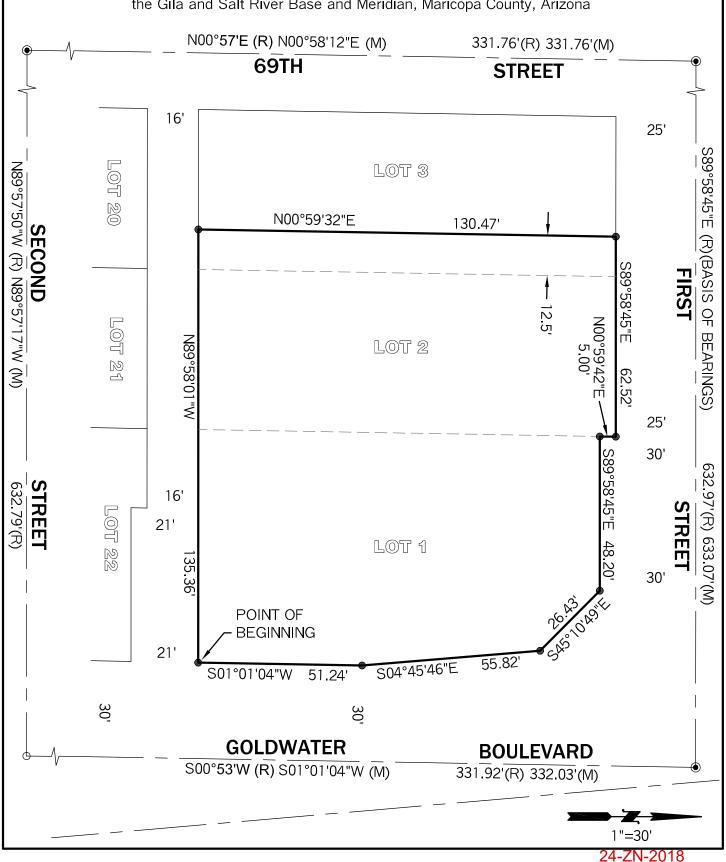
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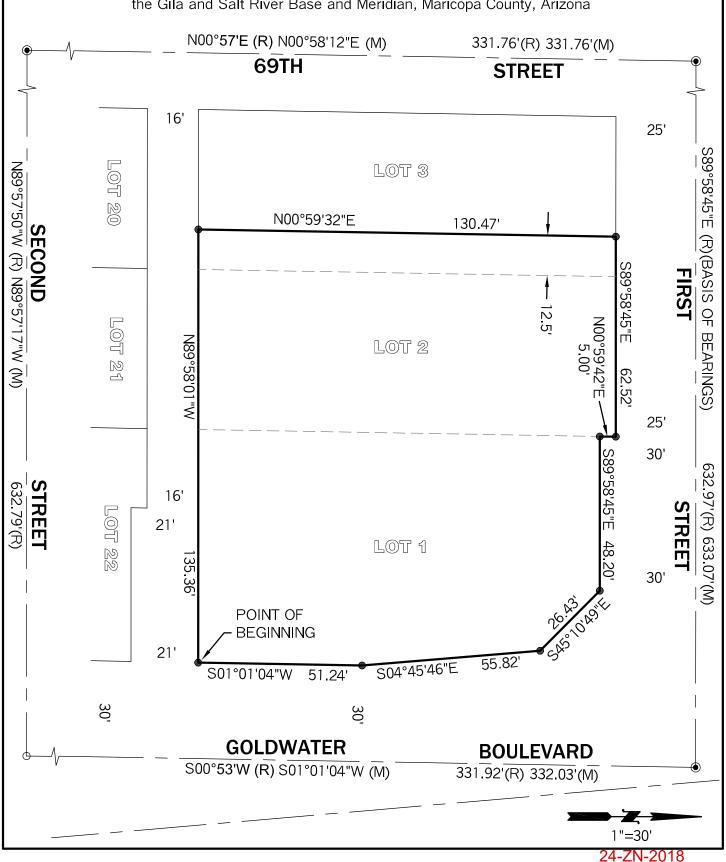
21081 THOMAS L. ROPE 8-10-18


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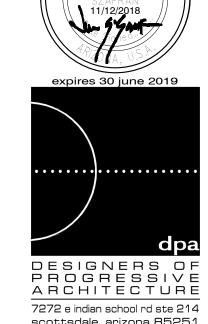




FLOOR PLANS - ROOF LEVEL / PARAPET LEVEL

CITY OF SCOTTSDALE REZONING/DR DEVELOPMENT SUBMITTAL PRE-APP CASE #486 - PA - 2018 WINERY S



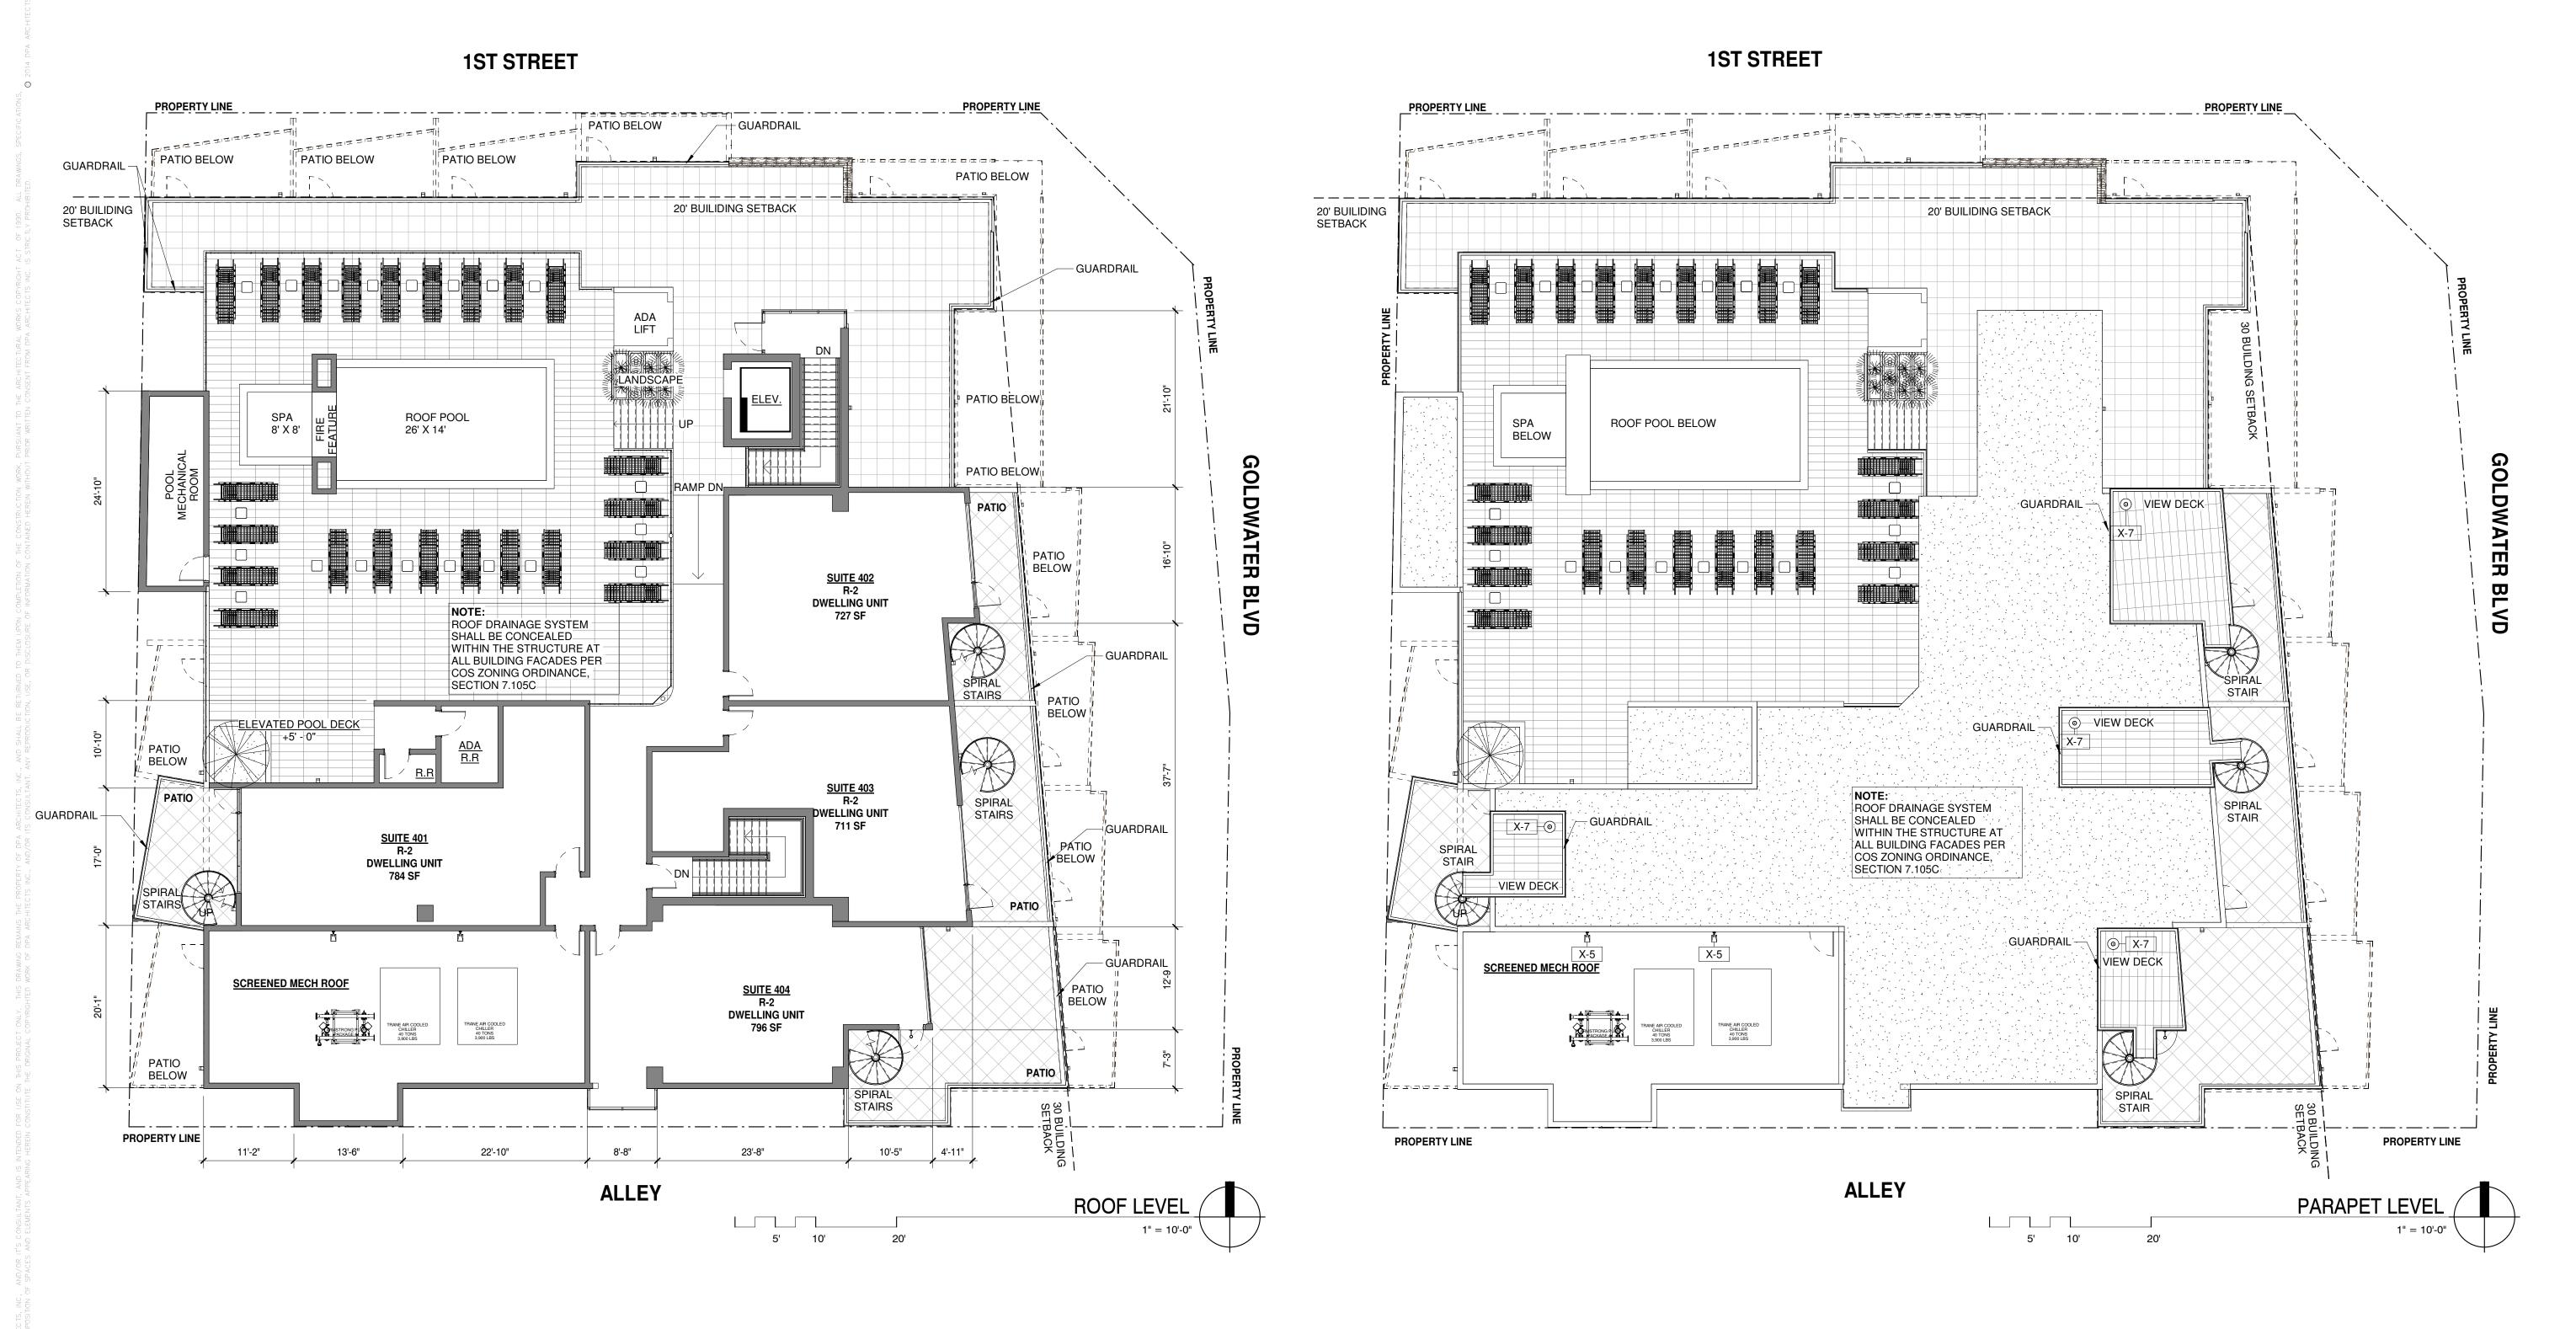

7272 e indian school rd ste 214 scottsdale, arizona 85251 telephone 480 941 4222 www.dpaarchitects.com


REVISION INFORMATION #: Description: Date:

drawn by: 11/13/18 A 100


24-ZN-2018 11/14/18

FLOOR PLANS - GARAGE LEVEL / STREET LEVEL CITY OF SCOTTSDALE REZONING/DR DEVELOPMENT SUBMITTAL PRE-APP CASE #486 - PA - 2018

STREET LEVEL FLOOR PLAN

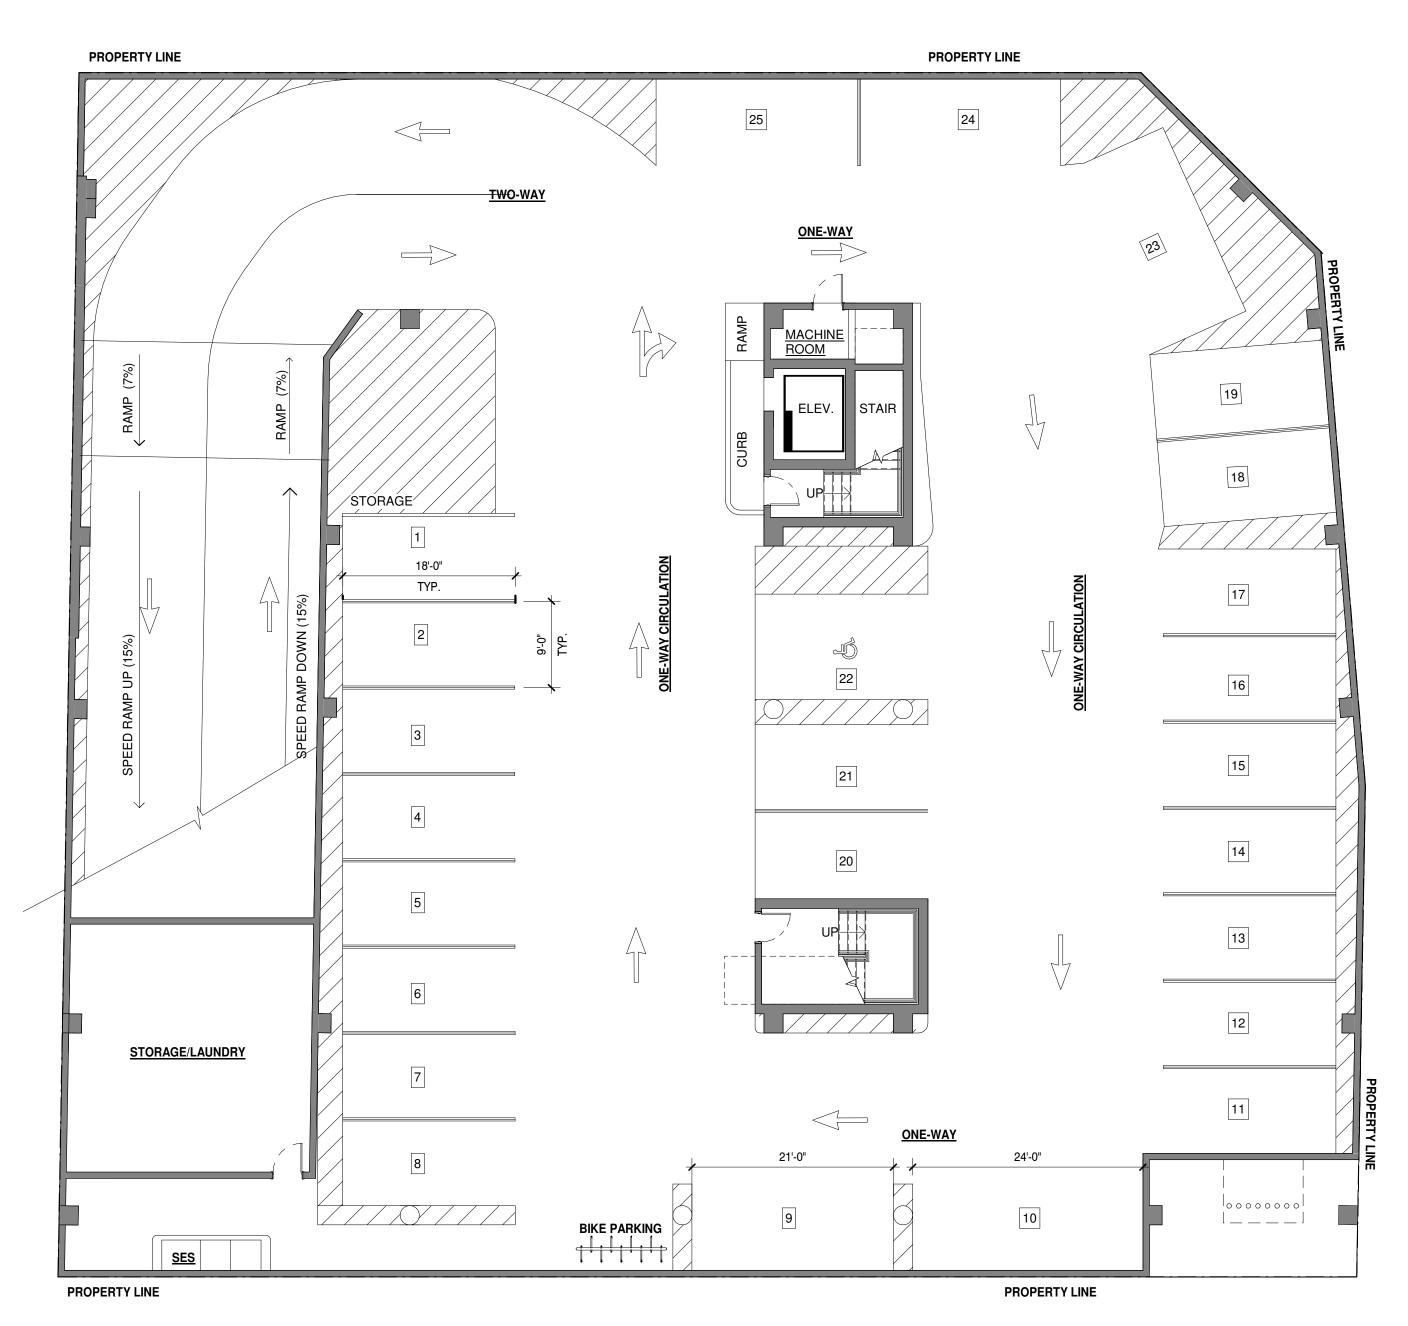



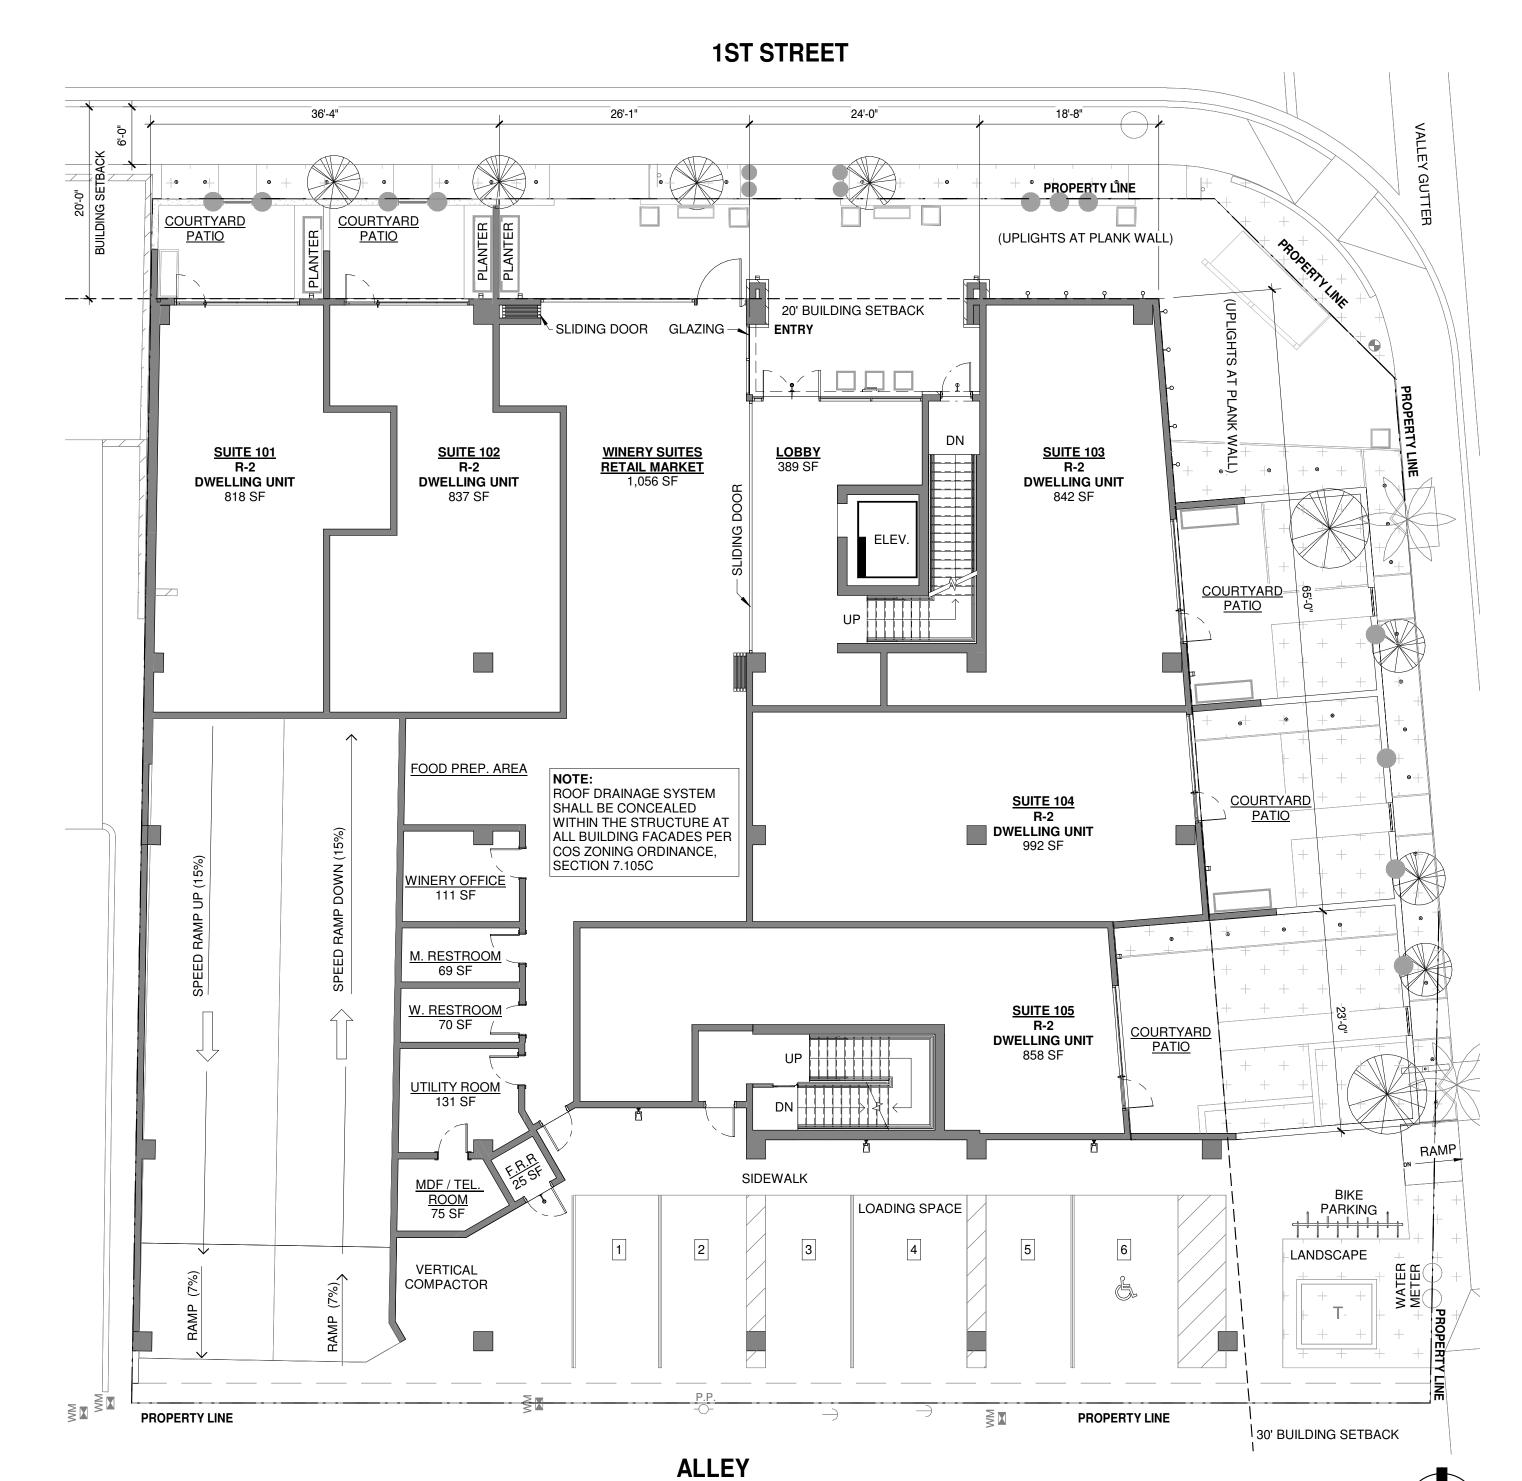

FLOOR PLANS - 2ND LEVEL / 3RD LEVEL


CITY OF SCOTTSDALE REZONING/DR DEVELOPMENT SUBMITTAL PRE-APP CASE #486 - PA - 2018 WINERY SUITES

expires 30 june 2019

DESIGNERS OF PROGRESSIVE ARCHITECTURE

7272 e indian school rd ste 214 scottsdale, arizona 85251 telephone 480 941 4222 www.dpaarchitects.com

REVISION INFORMATION
#: Description: Date:

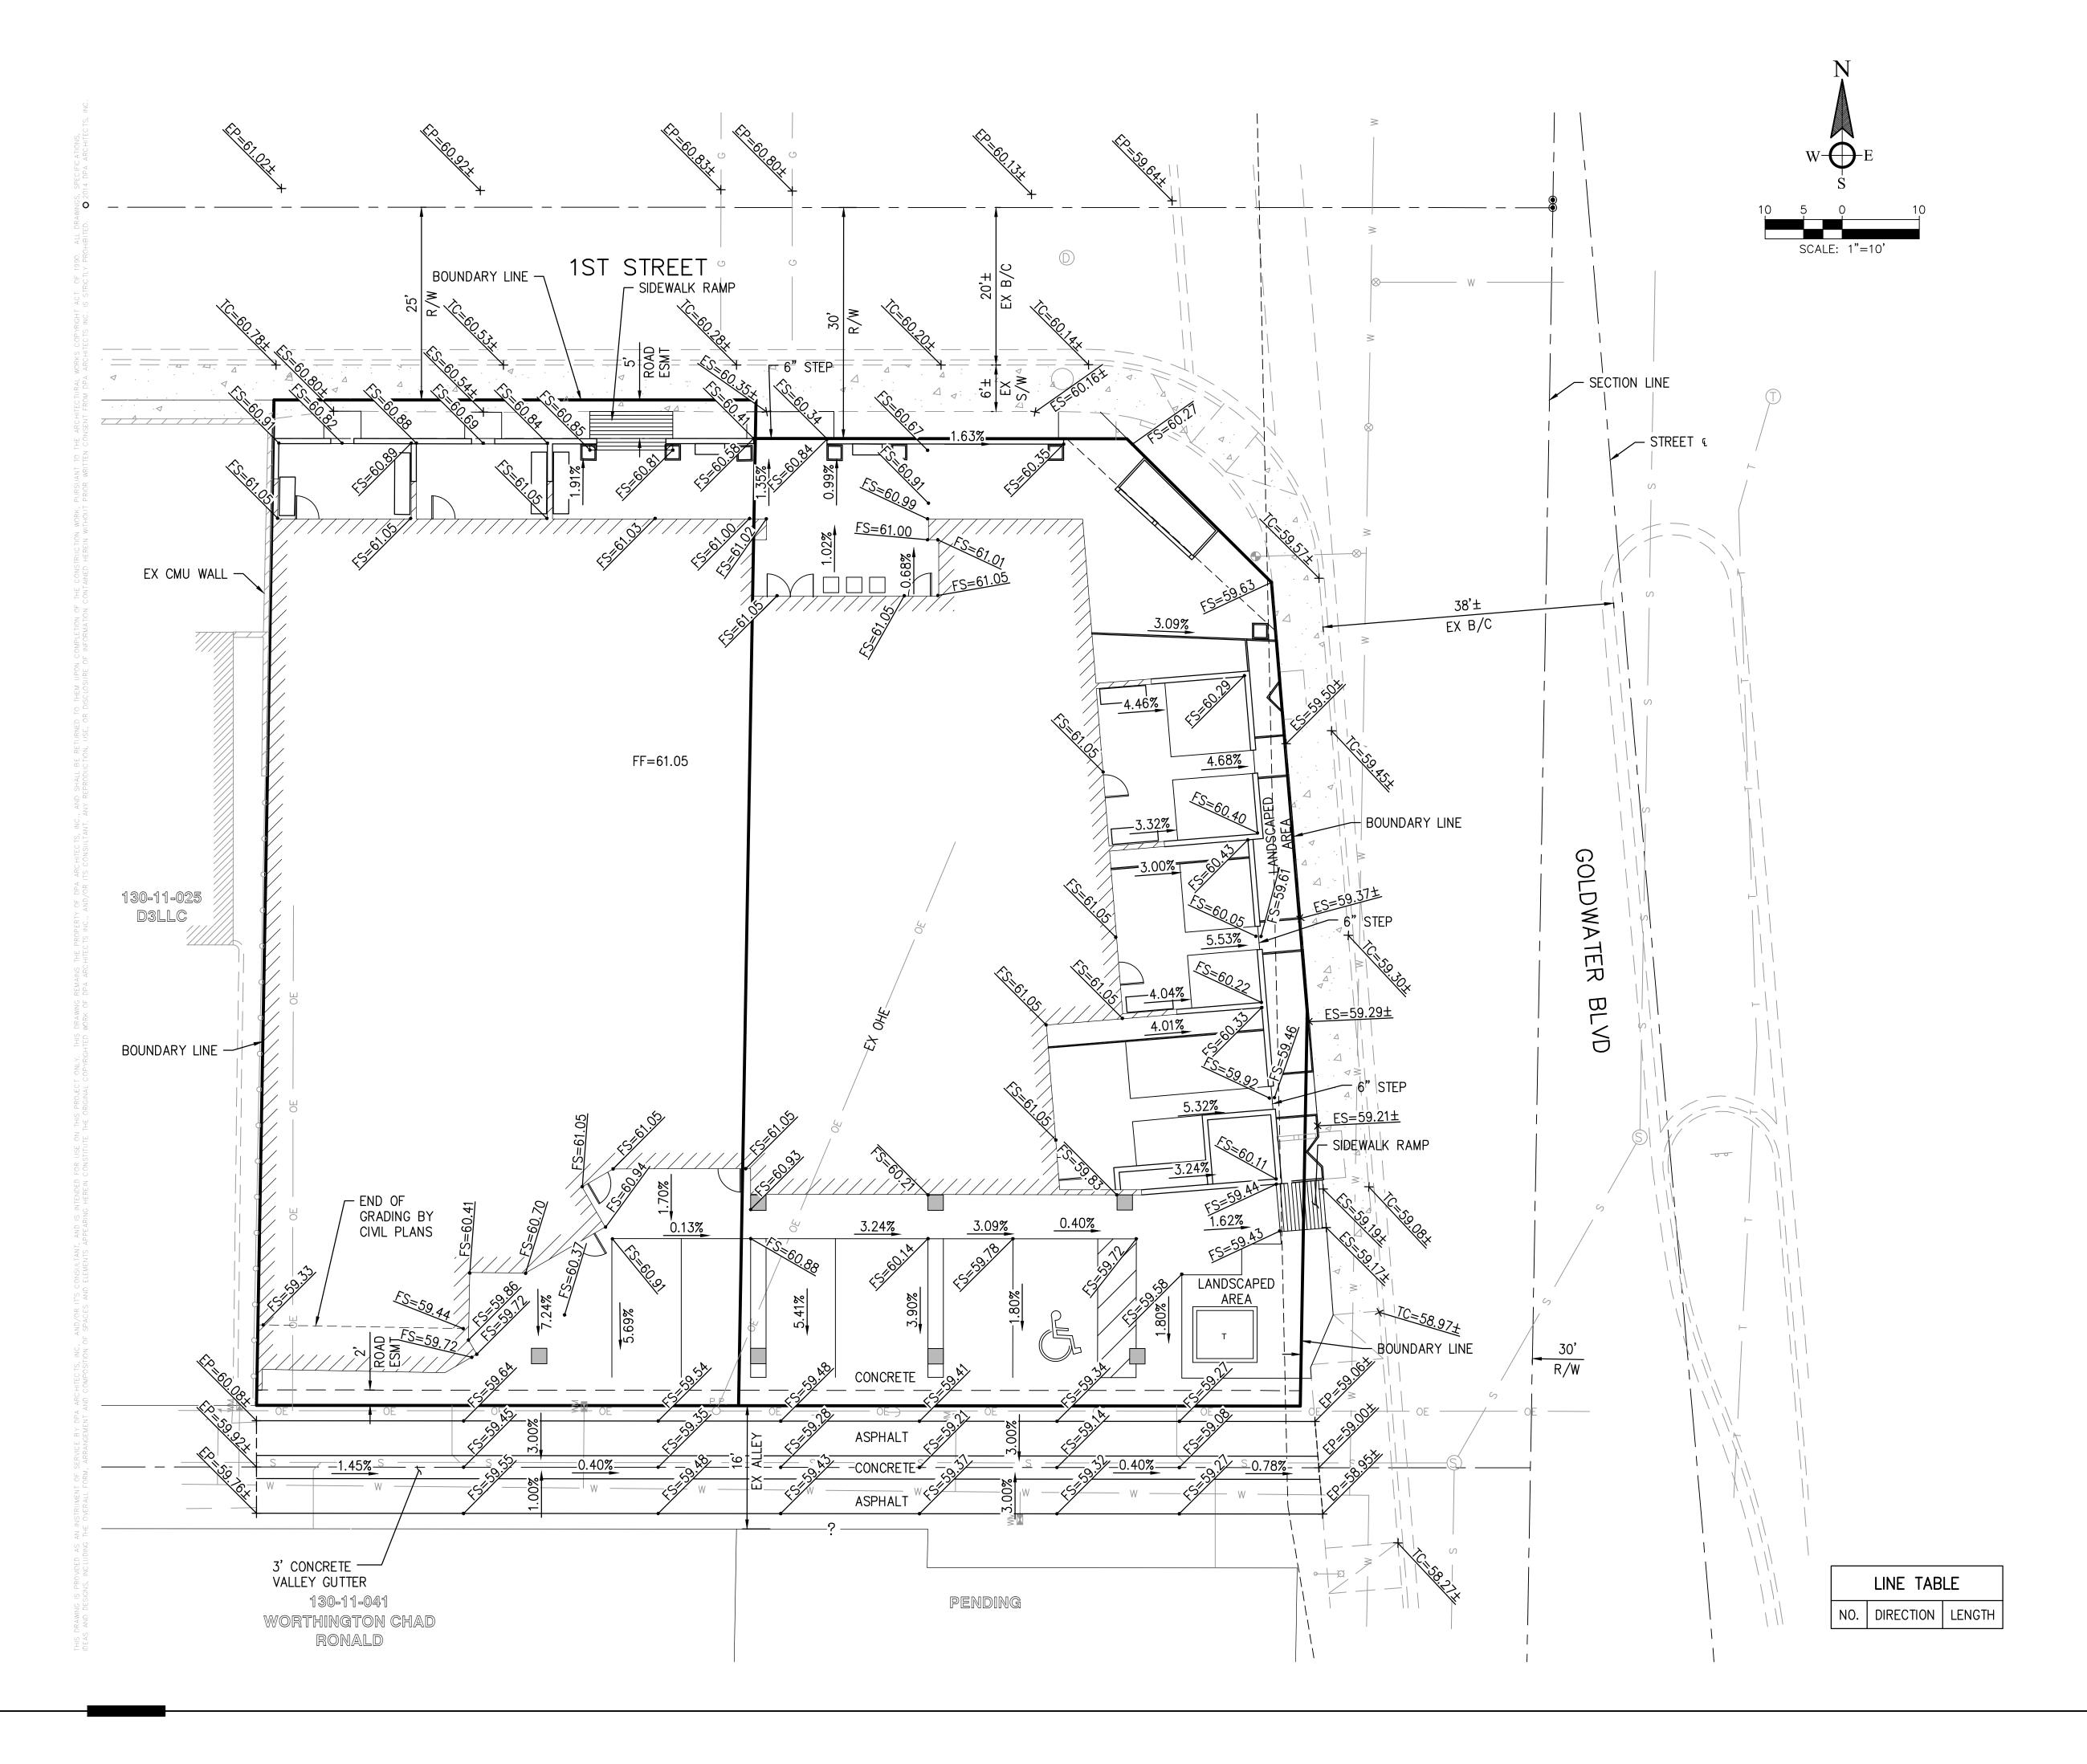

LEGEND

FS FINISHED SURFACE
ES EXISTING SURFACE
EP EXISTING PAVEMENT
TC EXISTING TOP OF CURB
CL CENTERLINE
PL PROPERTY LINE
ESMT EASEMENT
FF FINISHED FLOOR
CMU CONCRETE MASONRY UNIT
R/W RIGHT-OF-WAY
B/C BACK OF CURB

DESIGNERS OF PROGRESSIVE ARCHITECTURE

7272 e indian school rd ste 214 scottsdale, arizona 85251 telephone 480 941 4222 www.dpaarchitects.com

	REVISION INFOR	RMATION
#:	Description:	Date:

1054.02 11/9/2018

CV101+

PRELIMINARY GRADING PLAN




Key Notes (#)

- Planting area
 Raised steel planter
 Raised CMU planter w/ stone veneer

- Raised CMO planter W/ stone ver
 Fiberglass planter
 Site pottery
 Paver patio
 Synthetic turf
 Limit of overhead patio
 Existing city sign to remain
 Laser cut steel fence to match

- architectural panels on building
 11. Bicycle rack
 12. Patio wall 3" HT
 13. Patio gate
 14. Side walk ramp
 15. Step
 16. Existing tree grate
 17. Existing city catch basin to remain



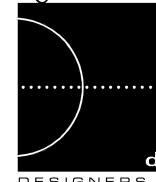

DESIGNERS OF PROGRESSIVE ARCHITECTURE 7272 e indian school rd ste 214 scottsdale, arizona 85251 telephone 480 941 4222 www.dpaarchitects.com


REVISION INFORMATION

project no.: 1054.03 2018-11-13

HARDSCAPE PLAN WestLand Resources

2020 N. Central Avenue
Suite 695
Phoenix, Arizona 85004
(602) 888-7000

CITY OF SCOTTSDALE REZONING DEVELOPMENT SUBMITTAL PRE-APP CASE #488-PA-2018

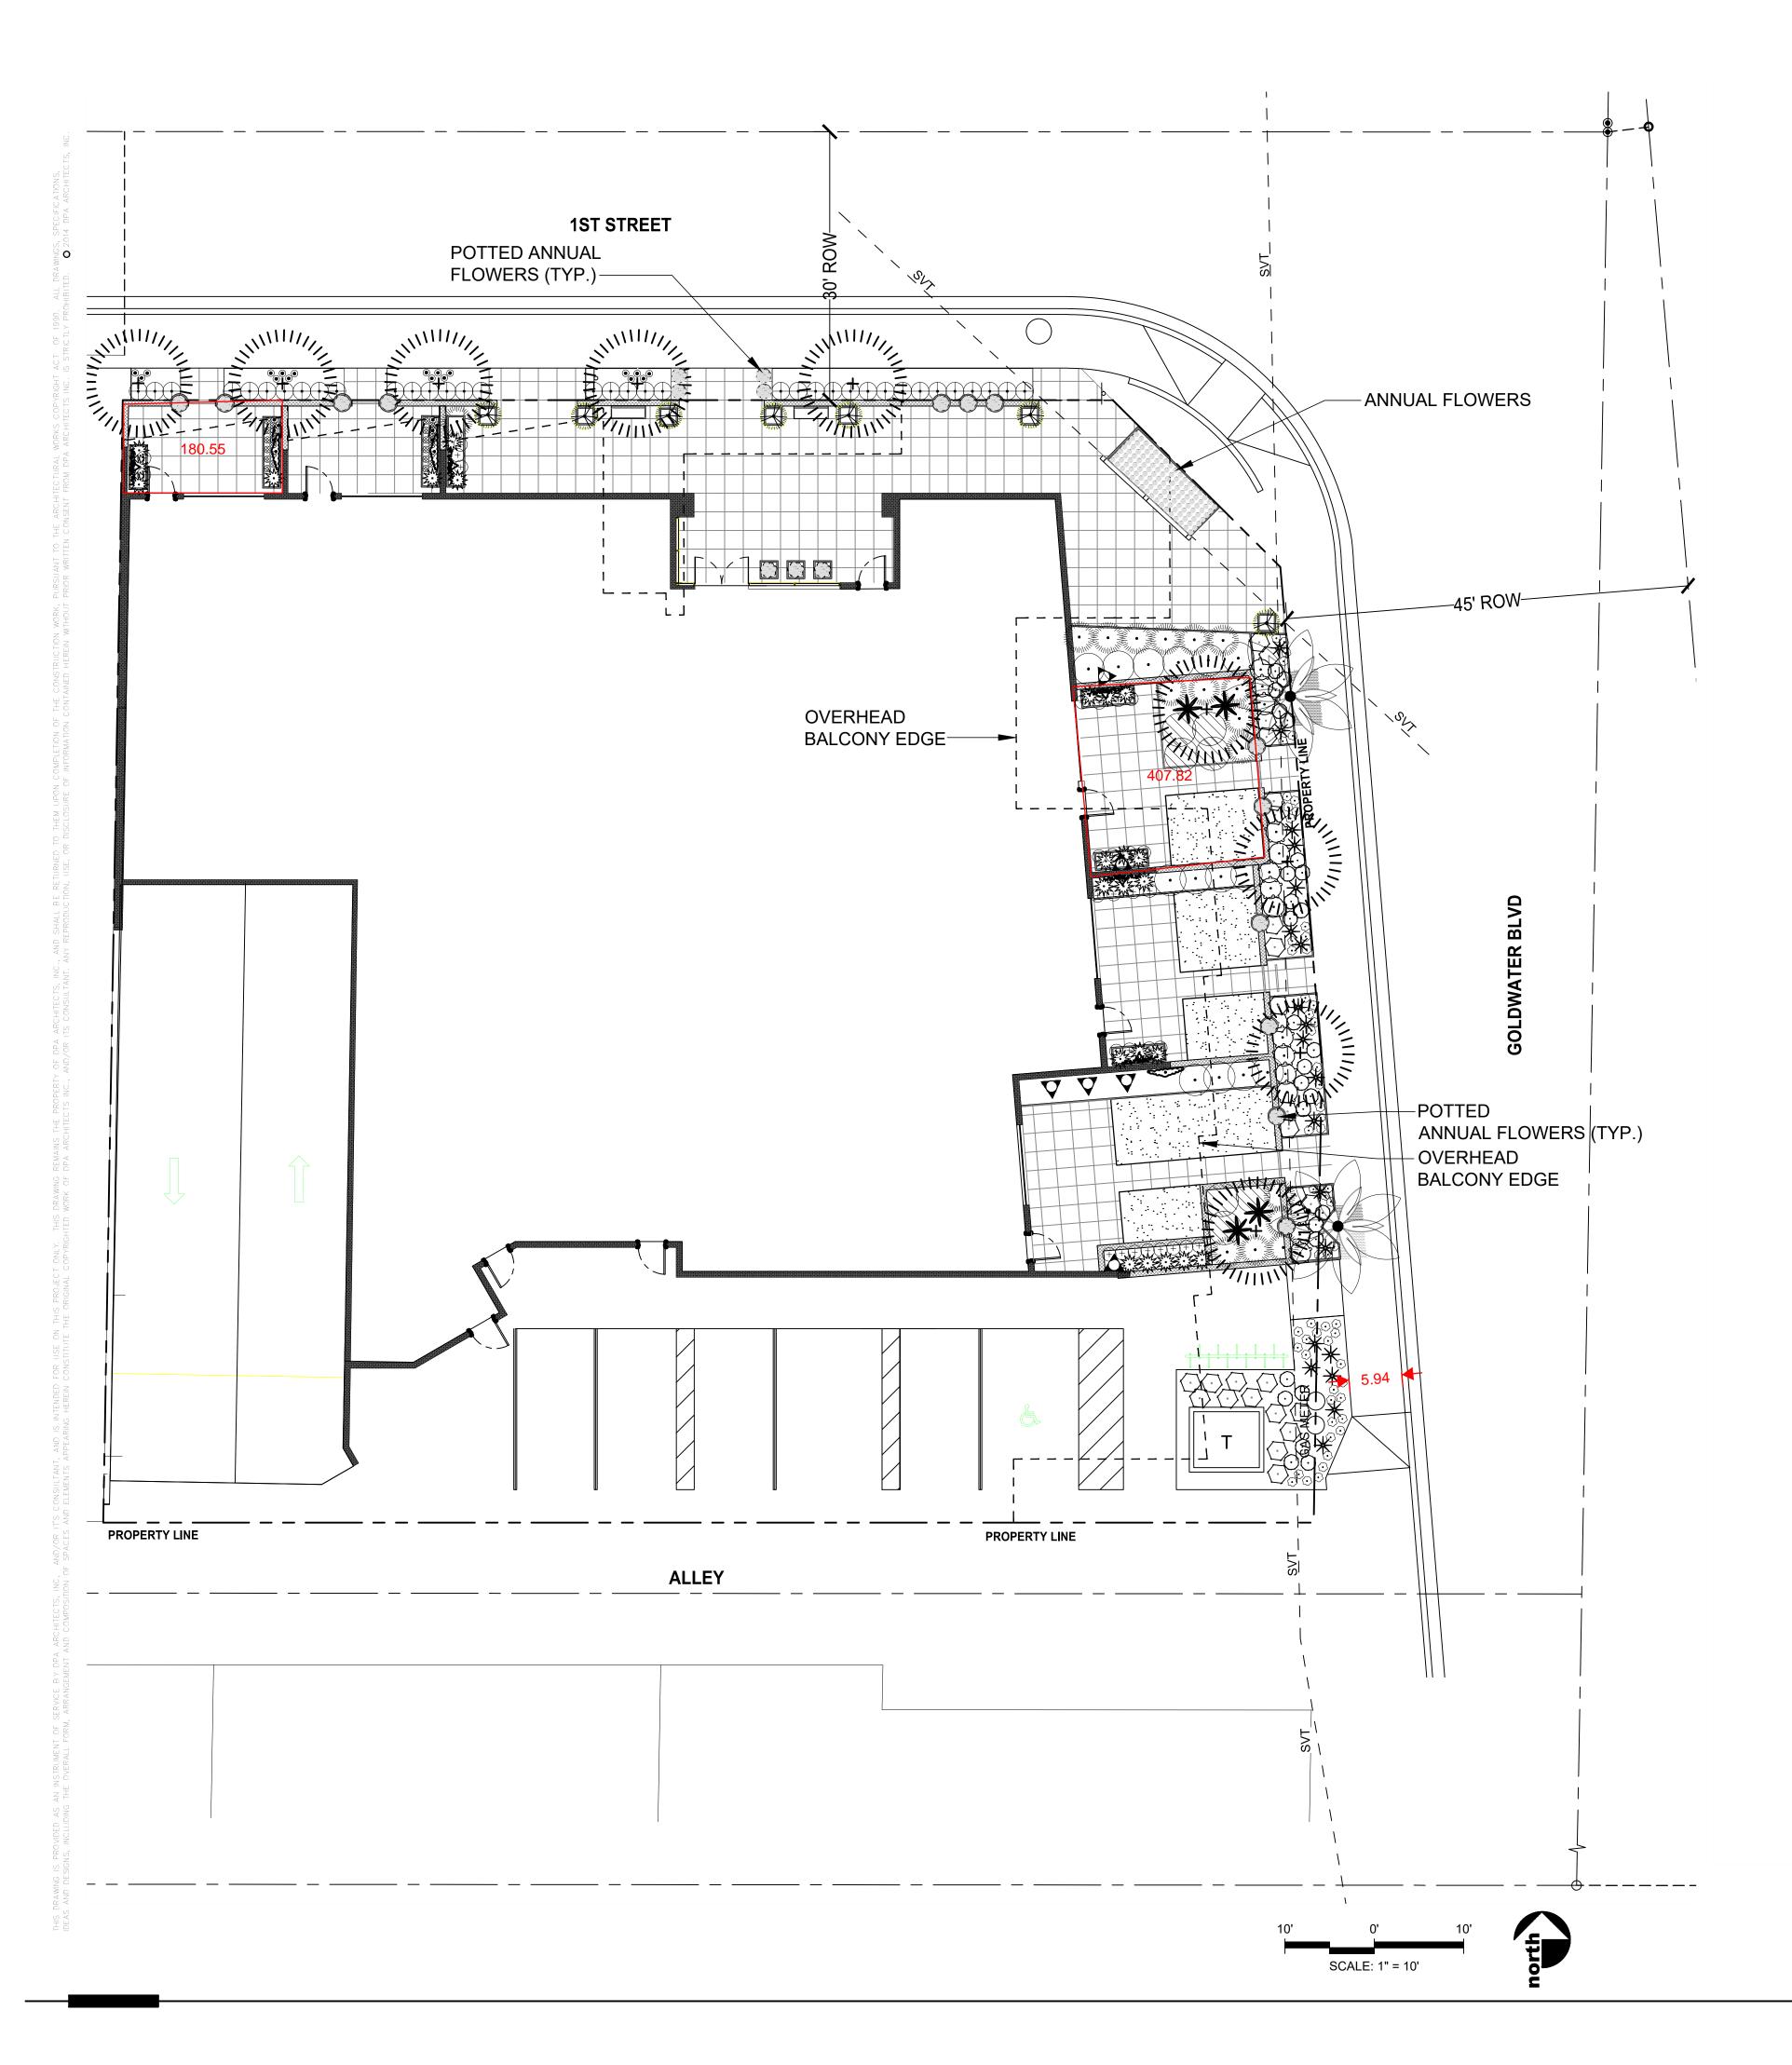

TREES	BOTANICAL NAME	COMMON NAME	SIZE	QTY
JIIII//	Acacia aneura	Mulga	3" Cal.	9
En Translation of the Control of the	Cupressus sempervirens 'Tiny Tower' TM	Tiny Tower Italian Cypress	5 gal.	7
	Washingtonia species	Fan Palm		2
SHRUBS	BOTANICAL NAME	COMMON NAME	SIZE	QTY
*	Agave desmettiana	Smooth Agave	5 gal.	4
	Aloe x `Blue Elf`	Aloe	1 gal.	26
	Callistemon citrinus `Little John`	Dwarf Bottle Brush	1 gal.	15
\odot	Chrysactinia mexicana	Damianita	1 gal.	26
ZWZ	Dietes vegeta	Fortnight Lily	1 gal.	24
•	Dodonaea viscosa	Hopseed Bush	5 gal.	14
•	Eremophila hygrophana `Blue Bells`	Blue Bells Emu	5 gal.	26
*	Hesperaloe parviflora `Brakelights` TM	Brakelights Yucca	1 gal.	20
	Ilex vomitoria `Stokes Dwarf`	Dwarf Yaupon	5 gal.	36
	Russelia equisetiformis	Coral Fountain Plant	5 gal.	17
	Tetraneuris acaulis	Angelita Daisy	1 gal.	59
ANNUALS/PERENNIALS	BOTANICAL NAME	COMMON NAME	SIZE	QTY
	Annual Flowers	Annual Flowers	4"	299
GROUND COVERS	BOTANICAL NAME	COMMON NAME	SIZE	QTY
	Eremophila prostrata `Outback Sunrise`	Outback Sunrise Emu	1 gal.	7
+	Trachelospermum asiaticum `Asiatic`	Asiatic Jasmine	1 gal.	29
	Tradescantia pallida	Purple Heart	1 gal.	22
VINE/ESPALIER	BOTANICAL NAME	COMMON NAME	SIZE	QTY
Δ	Ficus pumila	Creeping Fig	15 gal.	6
هنگ	Grewia occidentalis	Lavender Starflower	15 gal.	3
· salabarar	Trachelospermum jasminoides	Star Jasmine	5 gal.	5
NERT GROUND COVERS	BOTANICAL NAME	COMMON NAME	SIZE	QTY
	Decomposed Granite	1/2" Madison Gold	sq. ft.	4,309
	Synthetic Turf	Artificial Grass	sq. ft.	409 sf



DESIGNERS OF PROGRESSIVE ARCHITECTURE 7272 e indian school rd ste 214 scottsdale, arizona 85251 telephone 480 941 4222 www.dpaarchitects.com REVISION INFORMATION

drawn by: team project no.: 1054.03 2018-11-13

LANDSCAPE PLANTING PLAN

PEDESTRIAN AND VEHICULAR CIRCULATION

VEHICULAR CIRCULATION

CITY OF SCOTTSDALE REZONING/DR DEVELOPMENT SUBMITTAL PRE-APP CASE #486 - PA - 2018


LINE LARCED ARCED ARCED

drawn by:

11/13/18

AS101

24-ZN-2018 11/14/18

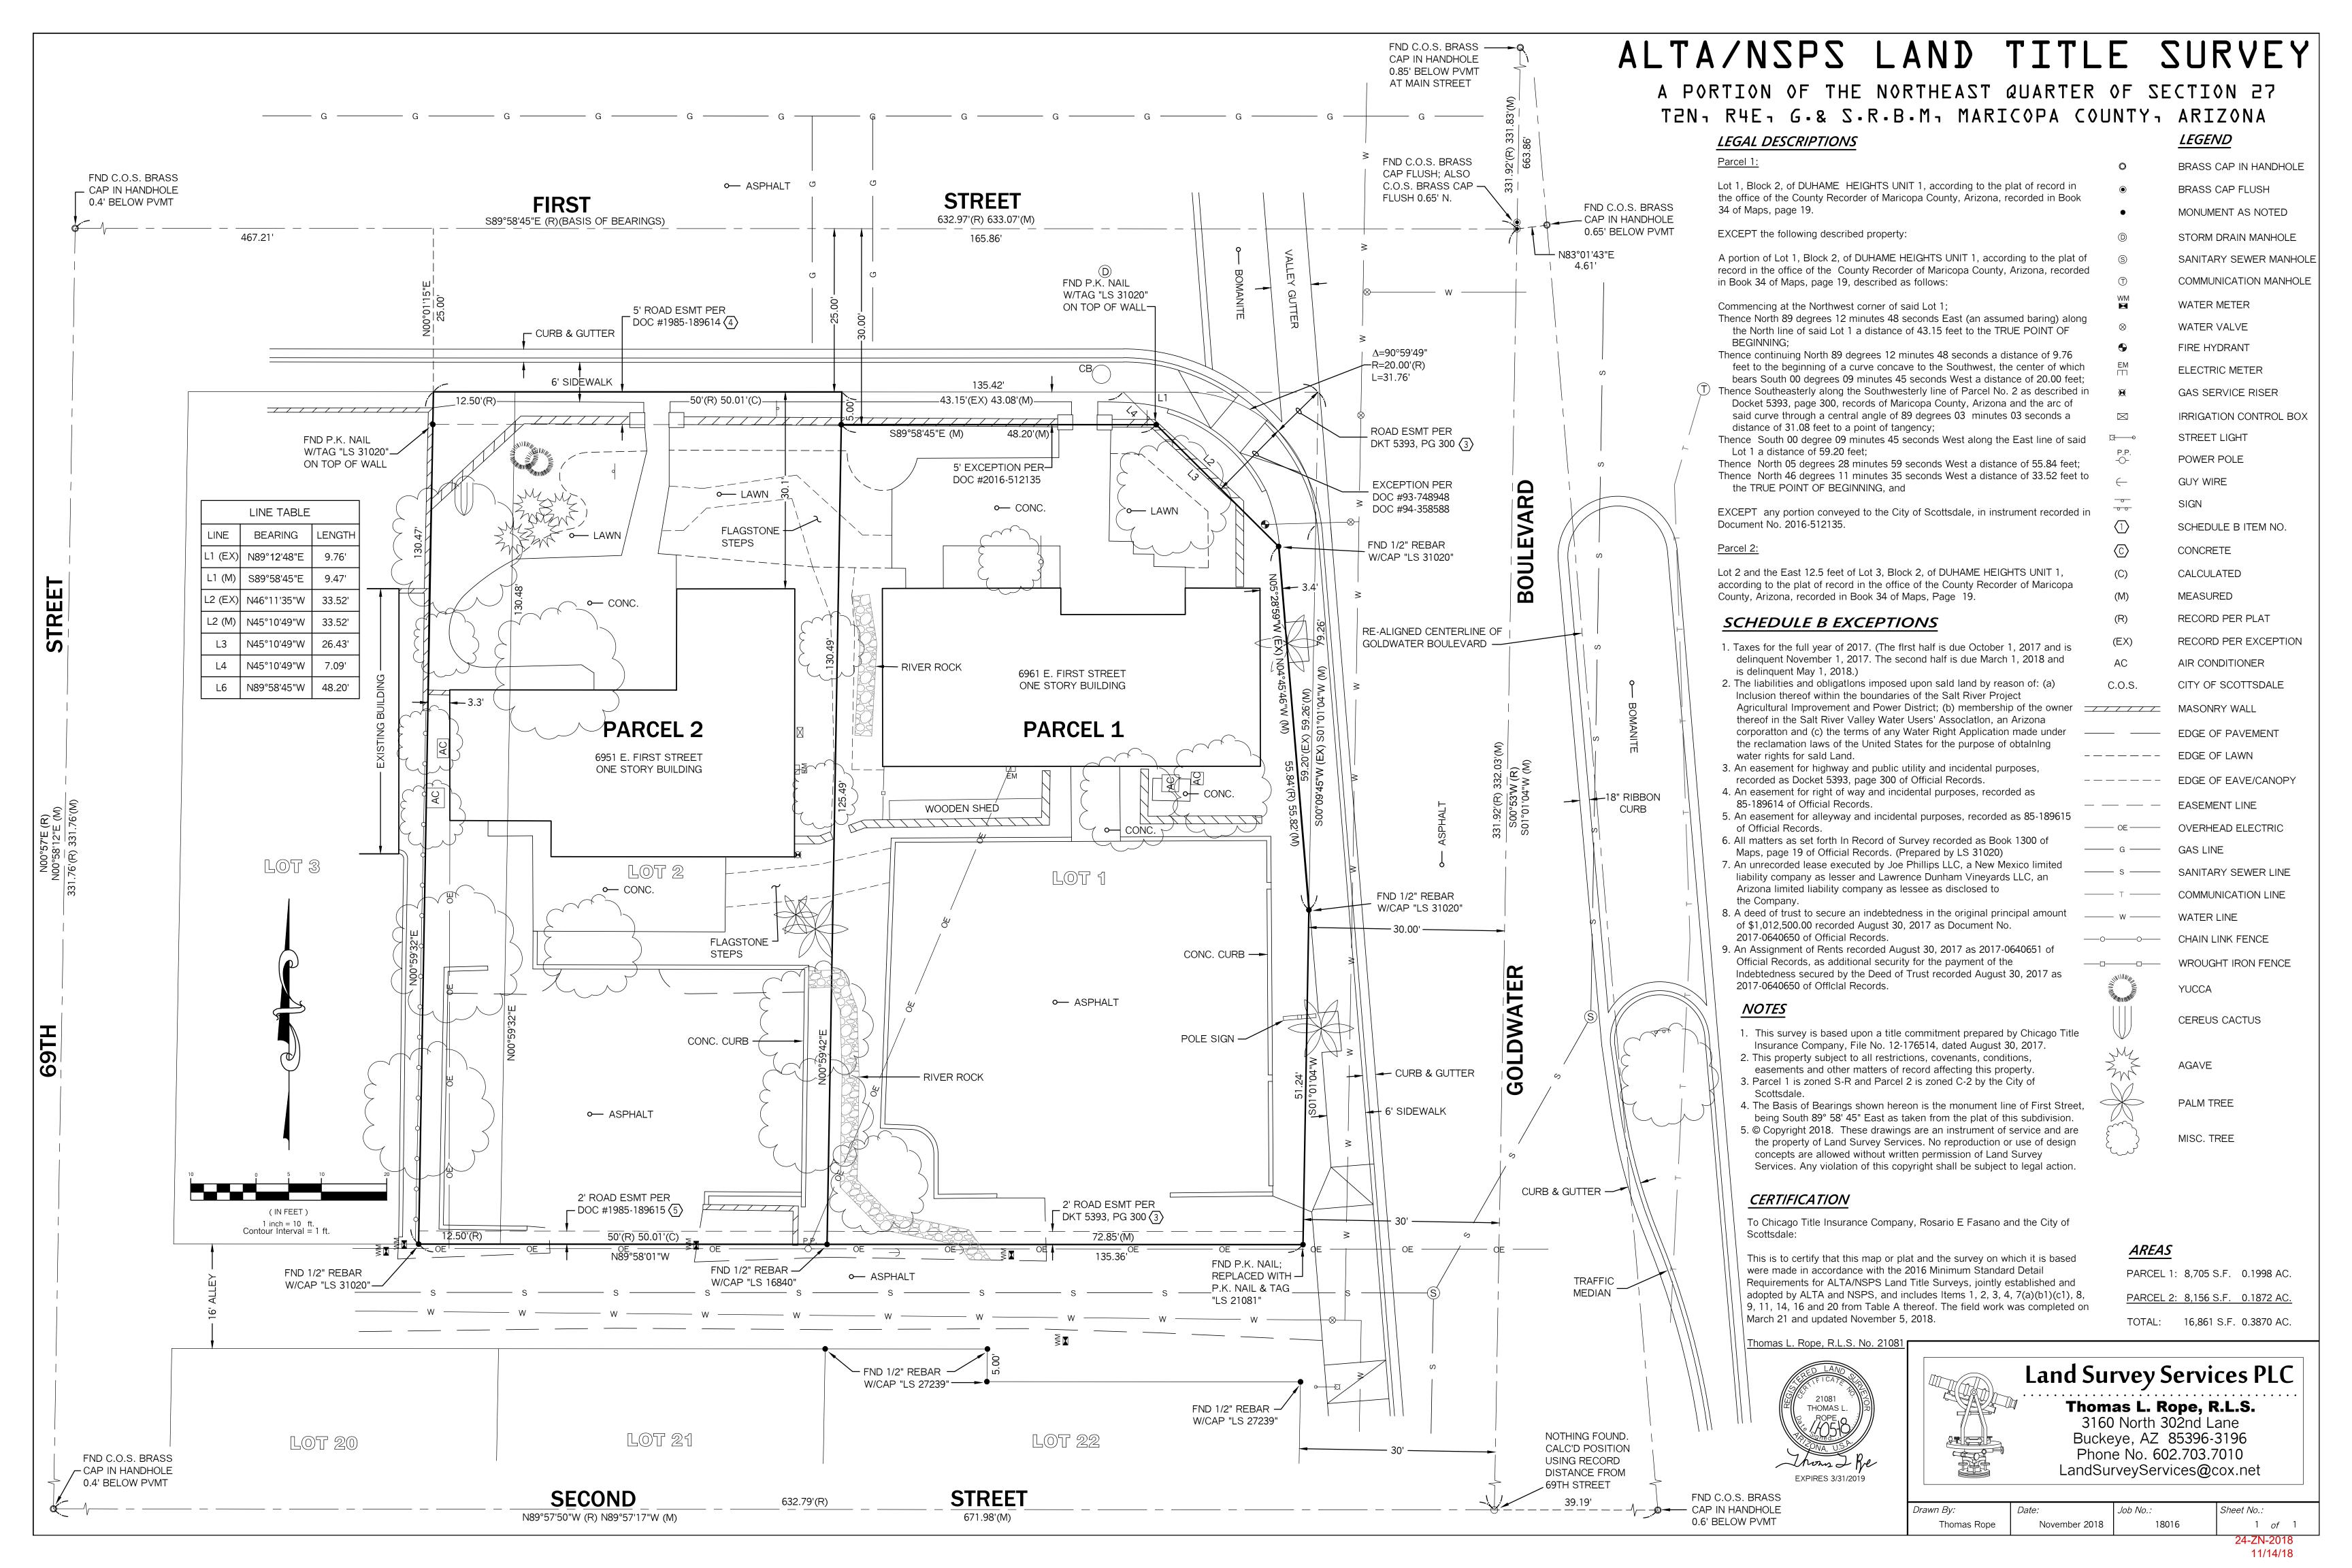

DESIGNERS OF PROGRESSIVE ARCHITECTURE 7272 e indian school rd ste 214 scottsdale, arizona 85251 telephone 480 941 4222 www.dpaarchitects.com

05/06/19

REZONING/DR DEVELOPMENT SUBMITTAL 24-ZN-2018 AND 52-DR-2018

FLOOR PLANS - 2ND LEVEL / 3RD LEVEL

CITY OF SCOTTSDALE REZONING/DR DEVELOPMENT SUBMITTAL 24-ZN-2018 AND 52-DR-2018 **ESIDENCES OF SCOTTSDALE**

DESIGNERS OF PROGRESSIVE ARCHITECTURE


7272 e indian school rd ste 214 scottsdale, arizona 85251 telephone 480 941 4222 www.dpaarchitects.com

REVISION INFORMATION

A 101 🛨

#: Description: Date:

drawn by:

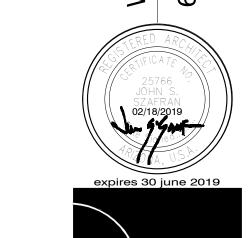

ESIDENCES OF SCOTTSDALE

DESIGNERS OF PROGRESSIVE ARCHITECTURE
7272 e indian school rd ste 214 scottsdale, arizona 85251 telephone 480 941 4222 www.dpaarchitects.com


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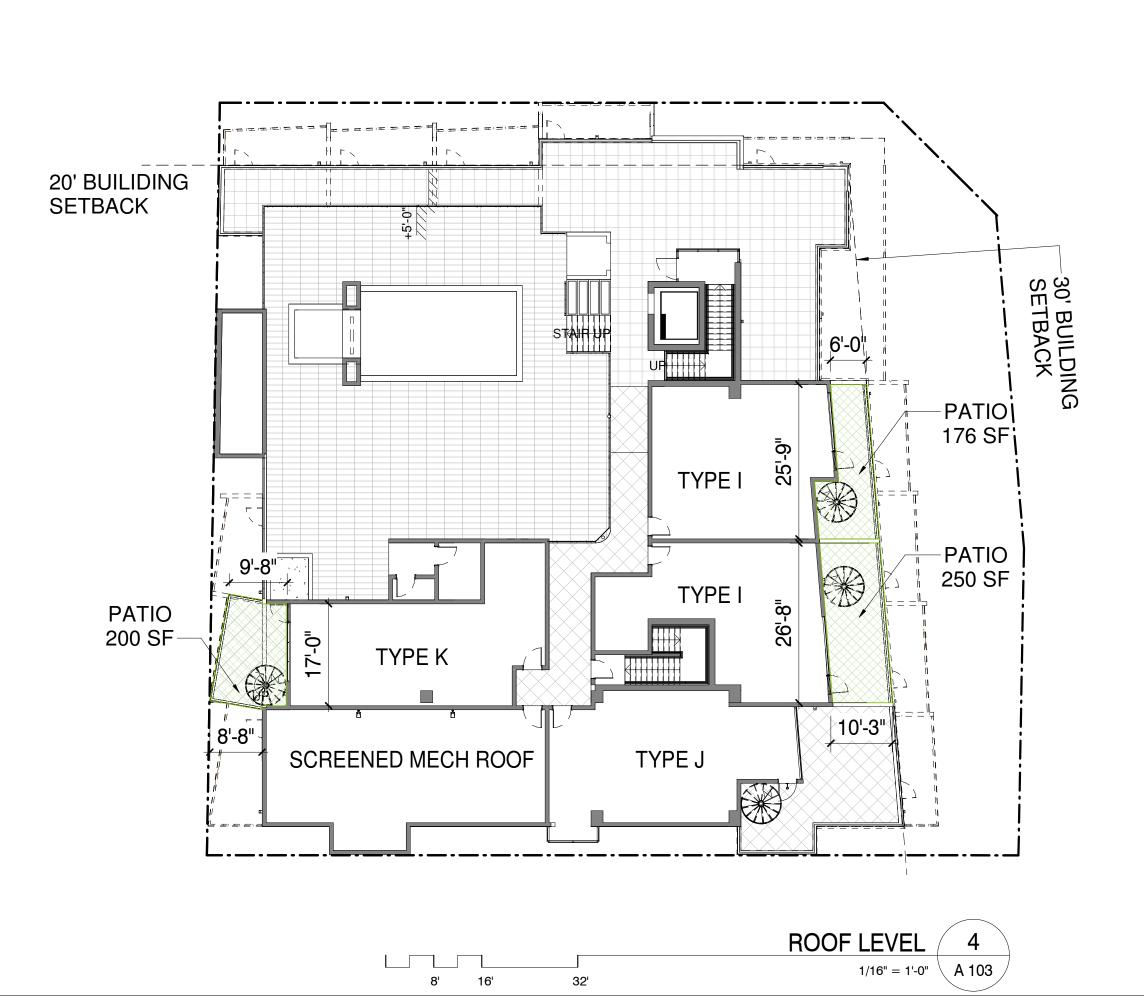
drawn by: YT
project no.: 18024
date: 05/06/19

A 100

FLOOR PLANS - GARAGE LEVEL / STREET LEVEL

CITY OF SCOTTSDALE
REZONING/DR DEVELOPMENT SUBMITTAL
24-ZN-2018 AND 52-DR-2018



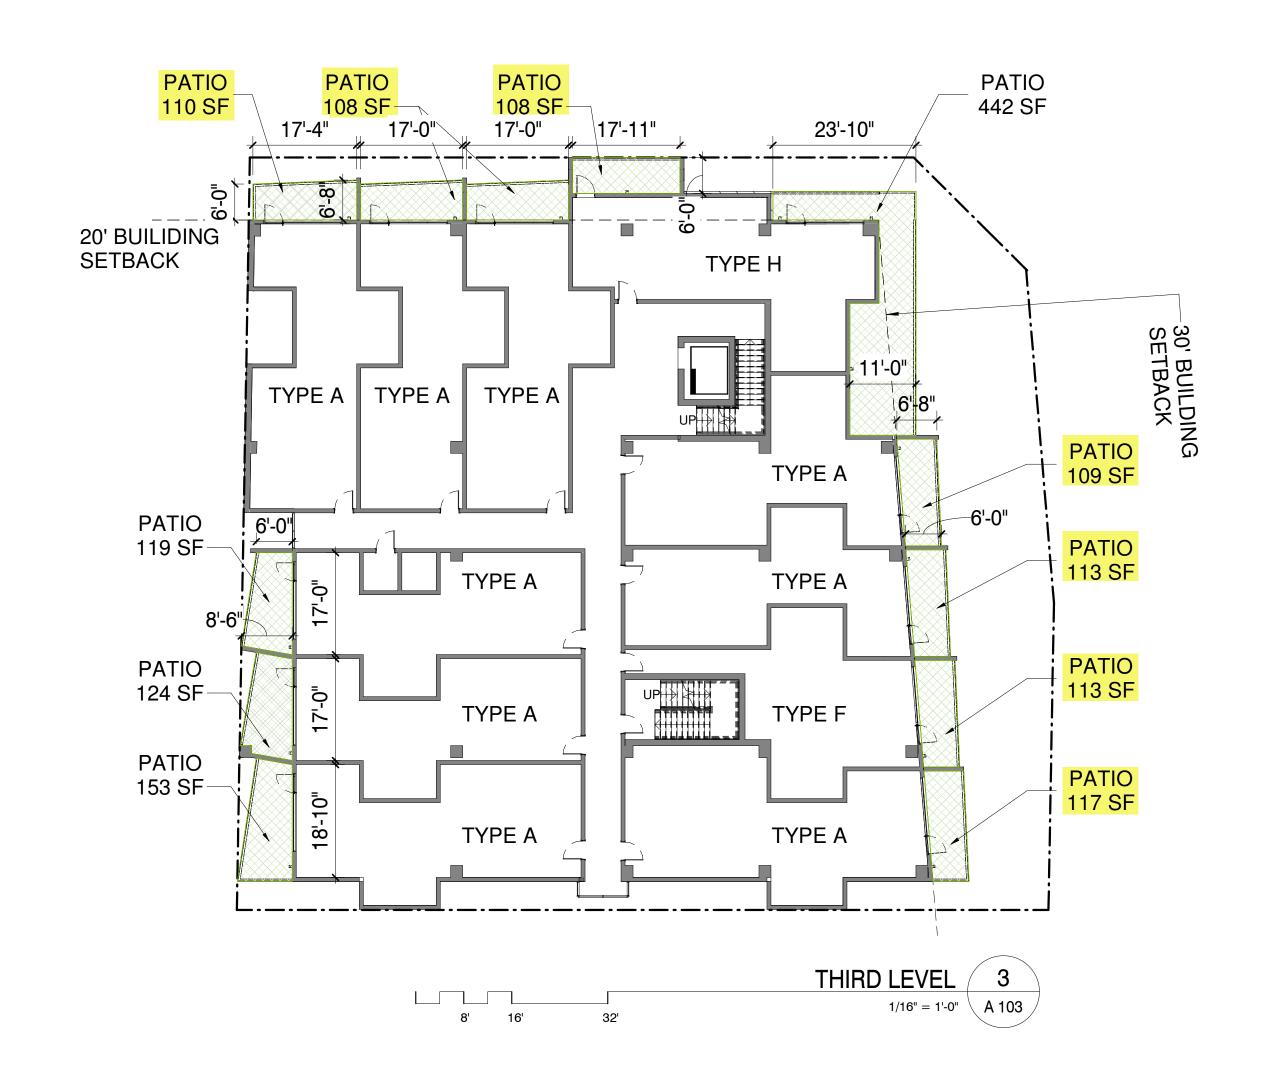

FLOOR PLAN WORKSHEET

CITY OF SCOTTSDALE
REZONING/DR DEVELOPMENT SUBMITTAL
24-ZN-2018 AND 52-DR-2018

drawn by:

05/06/19

A 103

Key Notes


- Planting area
 Raised steel planter
 Raised CMU planter w/ stone veneer

- Raised CMU planter w/ stone ven
 Fiberglass planter
 Site pottery
 Paver patio
 Synthetic turf
 Limit of overhead patio
 Existing city sign
 Laser cut steel fence to match architectural panels on building 11. Concrete paving
 12. Patio wall 3" HT
 13. Patio gate
 14. Side walk ramp

- 14. Side walk ramp
 15. Step
 16. Existing palm
 17. Existing city catch basin to remain
 18. Fire Hydrant
 19. Utilities

WINERY RESIDENCES OF SCOTTSDALE



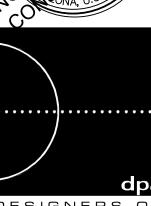

DESIGNERS OF PROGRESSIVE ARCHITECTURE 7272 e indian school rd ste 214 scottsdale, arizona 85251 telephone 480 941 4222 www.dpaarchitects.com

	REVISION INFORMATION							
	#:	Description:	Date:					
·								

drawn by:	team
project no.:	1054.03
date:	2019-05-06

HARDSCAPE PLAN 2020 N. Central Avenue Suite 695 WestLand Resources Phoenix, Arizona 85004 (602) 888-7000

CITY OF SCOTTSDALE REZONING DEVELOPMENT SUBMITTAL PRE-APP CASE #488-PA-2018

SCALE: 1" = 10'

PLANT SCHEDULE TREES	BOTANICAL NAME	COMMON NAME	SIZE	QTY
	ACACIA ANEURA	MULGA	36" BOX	9
Entry of The State	CUPRESSUS SEMPERVIRENS 'TINY TOWER' TM	TINY TOWER ITALIAN CYPRESS	15 GAL.	6
Envirolling.			0.00	
	PROSOPIS X 'PHOENIX' TM	HYBRID MESQUITE	36"	3
2.	WASHINGTONIA SPECIES	EXISTING FAN PALM		2
 SHRUBS	BOTANICAL NAME	COMMON NAME	SIZE	QTY
*	AGAVE DESMETTIANA	SMOOTH AGAVE	5 GAL.	8
*	ALOE X 'BLUE ELF'	ALOE	1 GAL.	23
\odot	CALLISTEMON CITRINUS 'LITTLE JOHN'	DWARF BOTTLE BRUSH	5 GAL.	7
\odot	CHRYSACTINIA MEXICANA	DAMIANITA	1 GAL.	29
Z.W.Z	DIETES VEGETA	FORTNIGHT LILY	5 GAL.	23
•	DODONAEA VISCOSA	HOPSEED BUSH	5 GAL.	15
	EREMOPHILA HYGROPHANA	BLUE BELLS	5 GAL.	74
*	HESPERALOE PARVIFLORA 'BRAKELIGHTS' TM	BRAKELIGHTS YUCCA	1 GAL.	35
+	ILEX VOMITORIA 'STOKES DWARF'	DWARF YAUPON	1 GAL.	1
	RUSSELIA EQUISETIFORMIS	CORAL FOUNTAIN PLANT	5 GAL.	10
lacktriangle	TETRANEURIS ACAULIS	ANGELITA DAISY	1 GAL.	46
\bigoplus	TEUCRIUM CHAMAEDRYS `PROSTRATUM`	PROSTRATE GERMANDER	1 GAL.	1
ANNUALS/PERENNIALS	BOTANICAL NAME	COMMON NAME	SIZE	QTY
	ANNUAL FLOWERS	ANNUAL FLOWERS	4"	411
GROUND COVER	BOTANICAL NAME	COMMON NAME	SIZE	QTY
	EREMOPHILA PROSTRATA 'OUTBACK SUNRISE'	OUTBACK SUNRISE EMU	1 GAL.	34
+	TRACHELOSPERMUM ASIATICUM 'ASIATIC'	ASIATIC JASMINE	1 GAL.	34
	TRADESCANTIA PALLIDA	PURPLE HEART	1 GAL.	22
VINE/ESPALIER	BOTANICAL NAME	COMMON NAME	SIZE	QTY
	FICUS PUMILA	CREEPING FIG	15 GAL.	7
~~~~	GREWIA OCCIDENTALIS	LAVENDER STARFLOWER	15 GAL.	3
-whiteh	TRACHELOSPERMUM JASMINOIDES	STAR JASMINE	5 GAL.	3
INERT GROUND COVER	BOTANICAL NAME	COMMON NAME	SIZE	QTY
	DECOMPOSED GRANITE	3/4" - MADISON GOLD	SQ. FT.	4,539 S
	SYNTHETIC TURF	ARTIFICIAL GRASS	SQ. FT.	71 SF



dpa
DESIGNERS OF
PROGRESSIVE
ARCHITECTURE

7272 e indian school rd ste 214 scottsdale, arizona 85251 telephone 480 941 4222 www.dpaarchitects.com

REVISION INFORMATION

	REVISION INFORM	ATION
#:	Description:	Date:

drawn by: team
project no.: 1054.03
date: 2019-05-06

LANDSCAPE PLANTING PLAN

2020 N. Central Avenue
Suite 695
Phoenix, Arizona 85004
(602) 888-7000

CITY OF SCOTTSDALE
REZONING DEVELOPMENT SUBMITTAL
PRE-APP CASE #488-PA-2018

NTING PLAN

2020 N. Central Avenue
Suite 695

# WINERY RESIDENCES OF SCOTTSDALE

A PROPERTY ASSEMBLAGE IN THE CITY OF SCOTTSDALE, ARIZONA, BEING A PART OF LOTS 1-3, BLOCK 2, DUHAME HEIGHTS UNIT 1, AS RECORDED IN BOOK 34 OF MAPS, PAGE 19, MARICOPA COUNTY, ARIZONA OWNER: FASSCO INVESTMENTS, LLC

### PARENT PARCEL LEGAL DESCRIPTION

### Parcel 1:

Lot 1, Block 2, of DUHAME HEIGHTS UNIT 1, according to the plat of record in the office of the County Recorder of Maricopa County, Arizona, recorded in Book 34 of Maps, page 19.

EXCEPT the following described property:

A portion of Lot 1, Block 2, of DUHAME HEIGHTS UNIT 1, according to the plat of record in the office of the County Recorder of Maricopa County, Arizona, recorded in Book 34 of Maps, page 19, described as follows:

Commencing at the Northwest corner of said Lot 1;

- Thence North 89 degrees 12 minutes 48 seconds East (an assumed baring) along the North line of said Lot 1 a distance of 43.15 feet to the TRUE POINT OF BEGINNING;

  Thence continuing North 89 degrees 12 minutes 48 seconds a distance of 9.76 feet
- to the beginning of a curve concave to the Southwest, the center of which bears South 00 degrees 09 minutes 45 seconds West a distance of 20.00 feet; Thence Southeasterly along the Southwesterly line of Parcel No. 2 as described in Docket 5393, page 300, records of Maricopa County, Arizona and the arc of said curve through a central angle of 89 degrees 03 minutes 03 seconds a
- distance of 31.08 feet to a point of tangency;
  Thence South 00 degree 09 minutes 45 seconds West along the East line of said
  Lot 1 a distance of 59.20 feet;
- Thence North 05 degrees 28 minutes 59 seconds West a distance of 55.84 feet;
  Thence North 46 degrees 11 minutes 35 seconds West a distance of 33.52 feet to the TRUE POINT OF BEGINNING, and

EXCEPT any portion conveyed to the City of Scottsdale, in instrument recorded in Document No. 2016-512135.

### Parcel 2:

Lot 2 and the East 12.5 feet of Lot 3, Block 2, of DUHAME HEIGHTS UNIT 1, according to the plat of record in the office of the County Recorder of Maricopa County, Arizona, recorded in Book 34 of Maps, Page 19.

### FEMA CERTIFICATION

The current FEMA Flood Insurance Rate Map (FIRM) for this area, Map No. 04013C2235L as published by FEMA on October 16, 2013, designates the property lies in Flood Hazard Zone X. (Areas of 0.2% annual chance of flood; areas of 1% annual chance of flood with average depths of less than 1 foot or with drainage areas less than 1 square mile; and areas protected by levees from 1% annual chance of flood.)

### BASIS OF BEARINGS


The Basis of Bearings shown hereon is the monument line of First Street, being South 89° 58' 45" East as taken from the plat of Duhame Heights Unit 1, recorded in Book 34 of Maps, Page 19.

### REFERENCE DOCUMENTS

DUHAME HEIGHTS UNITS 1 Book 34 maps, page 19

RECORD OF SURVEY Book 1300 maps, page 19

### VICINITY MAP

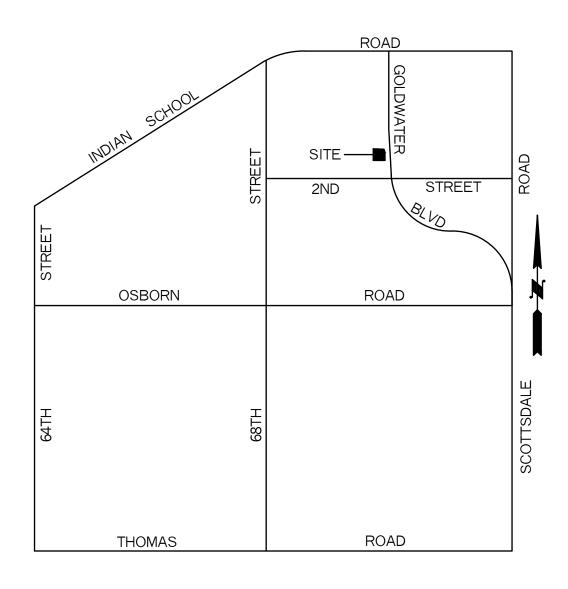

### **NOTES**

- 1. This plat is located within the City of Scottsdale Water Service Area and has been designated as having an assured water supply.
- Construction within the public utility easements, except by public agencies and utility companies, shall be limited to wood, wire or removable section-type fencing and must be in constructed in comformance with applicable CC&R's and design guidelines.
- 3. Electric lines are to be cosntructed underground as required by Arizona
- Corporation Commission General Order U-48.

  4. All new or relocated utilities will be constructed underground as required by the
- Arizona Corporation Commission general Order U-28.
- 5. Parcel 1 is zoned S-R and Parcel 2 is zoned C-2 under the City of Scottsdale Zoning Ordinance.
- 6. Affidavits of Correction or Amendment type letters concerning this plat are not valid. There will be no revisions to this plat without Development Engineering Manager's approval.

### OWNER

FASSCO Investments, LLC 919 E. Tekoa Avenue Gilbert, AZ 85298

### <u>AREA</u>

16,277 S.F. 0.3737 AC.

### **DEDICATION**

STATE OF ARIZONA ) )ss
COUNTY OF MARICOPA )

Know All Men By These Presents:

Fassco Investments, LLC, an Arizona limited liability company, owner, hereby assembles Lots 1 and 2 and a portion of Lot 3, Block 2 of "Duhame Heights Unit 1", a subdivision recorded in Book 34 of Maps, page 19 and being a portion of the Northwest quarter of Section 27, Township 2 North, Range 4 East, Gila & Salt River Base & Meridian, Maricopa County, Arizona under the name "Winery Residences of Scottsdale" as shown on the Final Plat. This Plat sets forth the location and gives the dimensions of the lots, streets and easements constituting the subdivision. Each lot and street shall be known by the number or name given on this Plat. The easements are dedicated for the purposes, and subject to the conditions, stated.

### PUBLIC STREETS:

FASSCO Investments, LLC, owner, Grantor, dedicates, in fee, to the City of Scottsdale, an Arizona municipal corporation, Grantee, the public streets as shown hereon. See SRC, Chapter 47, as amended, for Grantor's maintenance obligations. Without limitation, Grantee may (1) grade, fill, drain, pave, construct, operate, maintain, repair, and rebuild roads, highways, utility lines, pipes and related facilities, with bridges, culverts, drainage ways, ramps, sidewalks, curbs, gutters, cuts and other related improvements, and (2) cut and trim branches, trees and growth that extend into the improvements, to prevent interference with the efficient maintenance and operation of the improvements.

### Public Non-Motorized Access (PNMA):

A perpetual, non-exclusive easement shown hereon, upon, over, under and across the property on this plat, for all forms of non-motorized transportation together with motorized emergency, law enforcement, and service vehicles, and for construction, operation, use, maintenance, repair, modification and replacement from time to time of improvements related thereto. See SRC, Chapter 47, as amended, for maintenance obligations.

### Sight Distance (SD):

A perpetual, non-exclusive easement shown hereon upon, over, under and across the property on this plat, to preserve an area free of obstructions to enhance traffic safety visibility. In the easement, Grantor shall not place or allow any buildings, walls, trees, structures, screens or other obstructions from 18 to 96 inches high above the elevation of the adjacent street. However, the Grantee may allow poles or tree trunks that Grantee determines, in writing, do not adversely affect traffic safety visibility.

### In witness whereof:

Grantor warrants and covenants to Grantee and its successors and assigns that Grantor is lawfully seized and possessed of the Property; that Grantor has a good and lawful right to make the conveyance described herein; and that Grantee shall have title and quiet possession against the claims of all persons. The person executing this document on behalf of a corporation, trust or other organization warrants his or her authority to do so and that all persons necessary to bind Grantor have joined in this document. This document runs with the land in favorof Grantee's successors and assigns.

Dated this	day of	, 2019
Grantor:		
For		

### **ACKNOWLEDGMENT**

STATE OF ARIZONA	) )ss		
COUNTY OF MARICOPA	)		
This document was ack	nowledged before me this	day of	, 20
Ву	for and on behalf of_		
Notary Public:			
My commission expires	i		

### RATIFICATION

As beneficiary under that certain deed of trust recorded in the County Recorder's Office, Maricopa County, Arizona, in Recorder's Number 2017-0640650, the undersigned hereby ratifies, approves and confirmation is given to said dedications as stated in this plat as to the interest of the undersigned. The person signing for Beneficiary warrants and represents they have power and authority to do so.

	KS Statebank	
Title	e of Position	Date

### **ACKNOWLEDGMENT**

STATE OF ARIZONA	)ss
COUNTY OF MARICOPA	)
This document was ack 2019.	nowledged before me this day of
Ву	for and on behalf of
	or and on sonal or
Notary Public:	

### <u>APPROVALS</u>

My commission expires: _____

This plat has been reviewed for compliance with the City of Scottsdale's Design Standards and Policy Manual specifications.

By:		
,	Chief Development Officer	Date
the	s subdivision has been reviewed for compliance with deve City of Scottsdale's Development Review Board (DRB) Ca Zoning Case(s) No. 24-ZN-2018, and all case related stip	ase No. 52-DR-2018,

Date


### LAND SURVEYOR'S CERTIFICATION


Development Engineering Manager's

### This is to certify that:


- 1. I am a Land Surveyor registered to practice in Arizona;
- 2. This plat was made under my direction;3. This plat meets the "Minimum Standards for Arizona Land Boundary Surveys";
- The survey and division of the subject property described and platted hereon were made during the Month of August, 2018;
- 5. The survey is true and complete as shown;6. Monuments shown actually exist;
- 7. Their positions are correctly shown; and8. Said monuments are sufficient to enable the survey to be retraced.

Thomas L. Rope, R.L.S. 21081

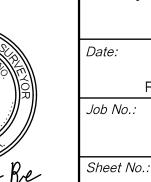

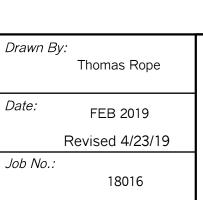


1 *of* 

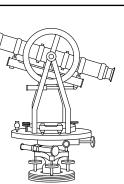

# Thomas L. Rope, R.L.S. 3160 North 302nd Lane


3160 North 302nd Lane Buckeye, AZ 85396-3196 Phone No. 602.703.7010 LandSurveyServices@cox.net



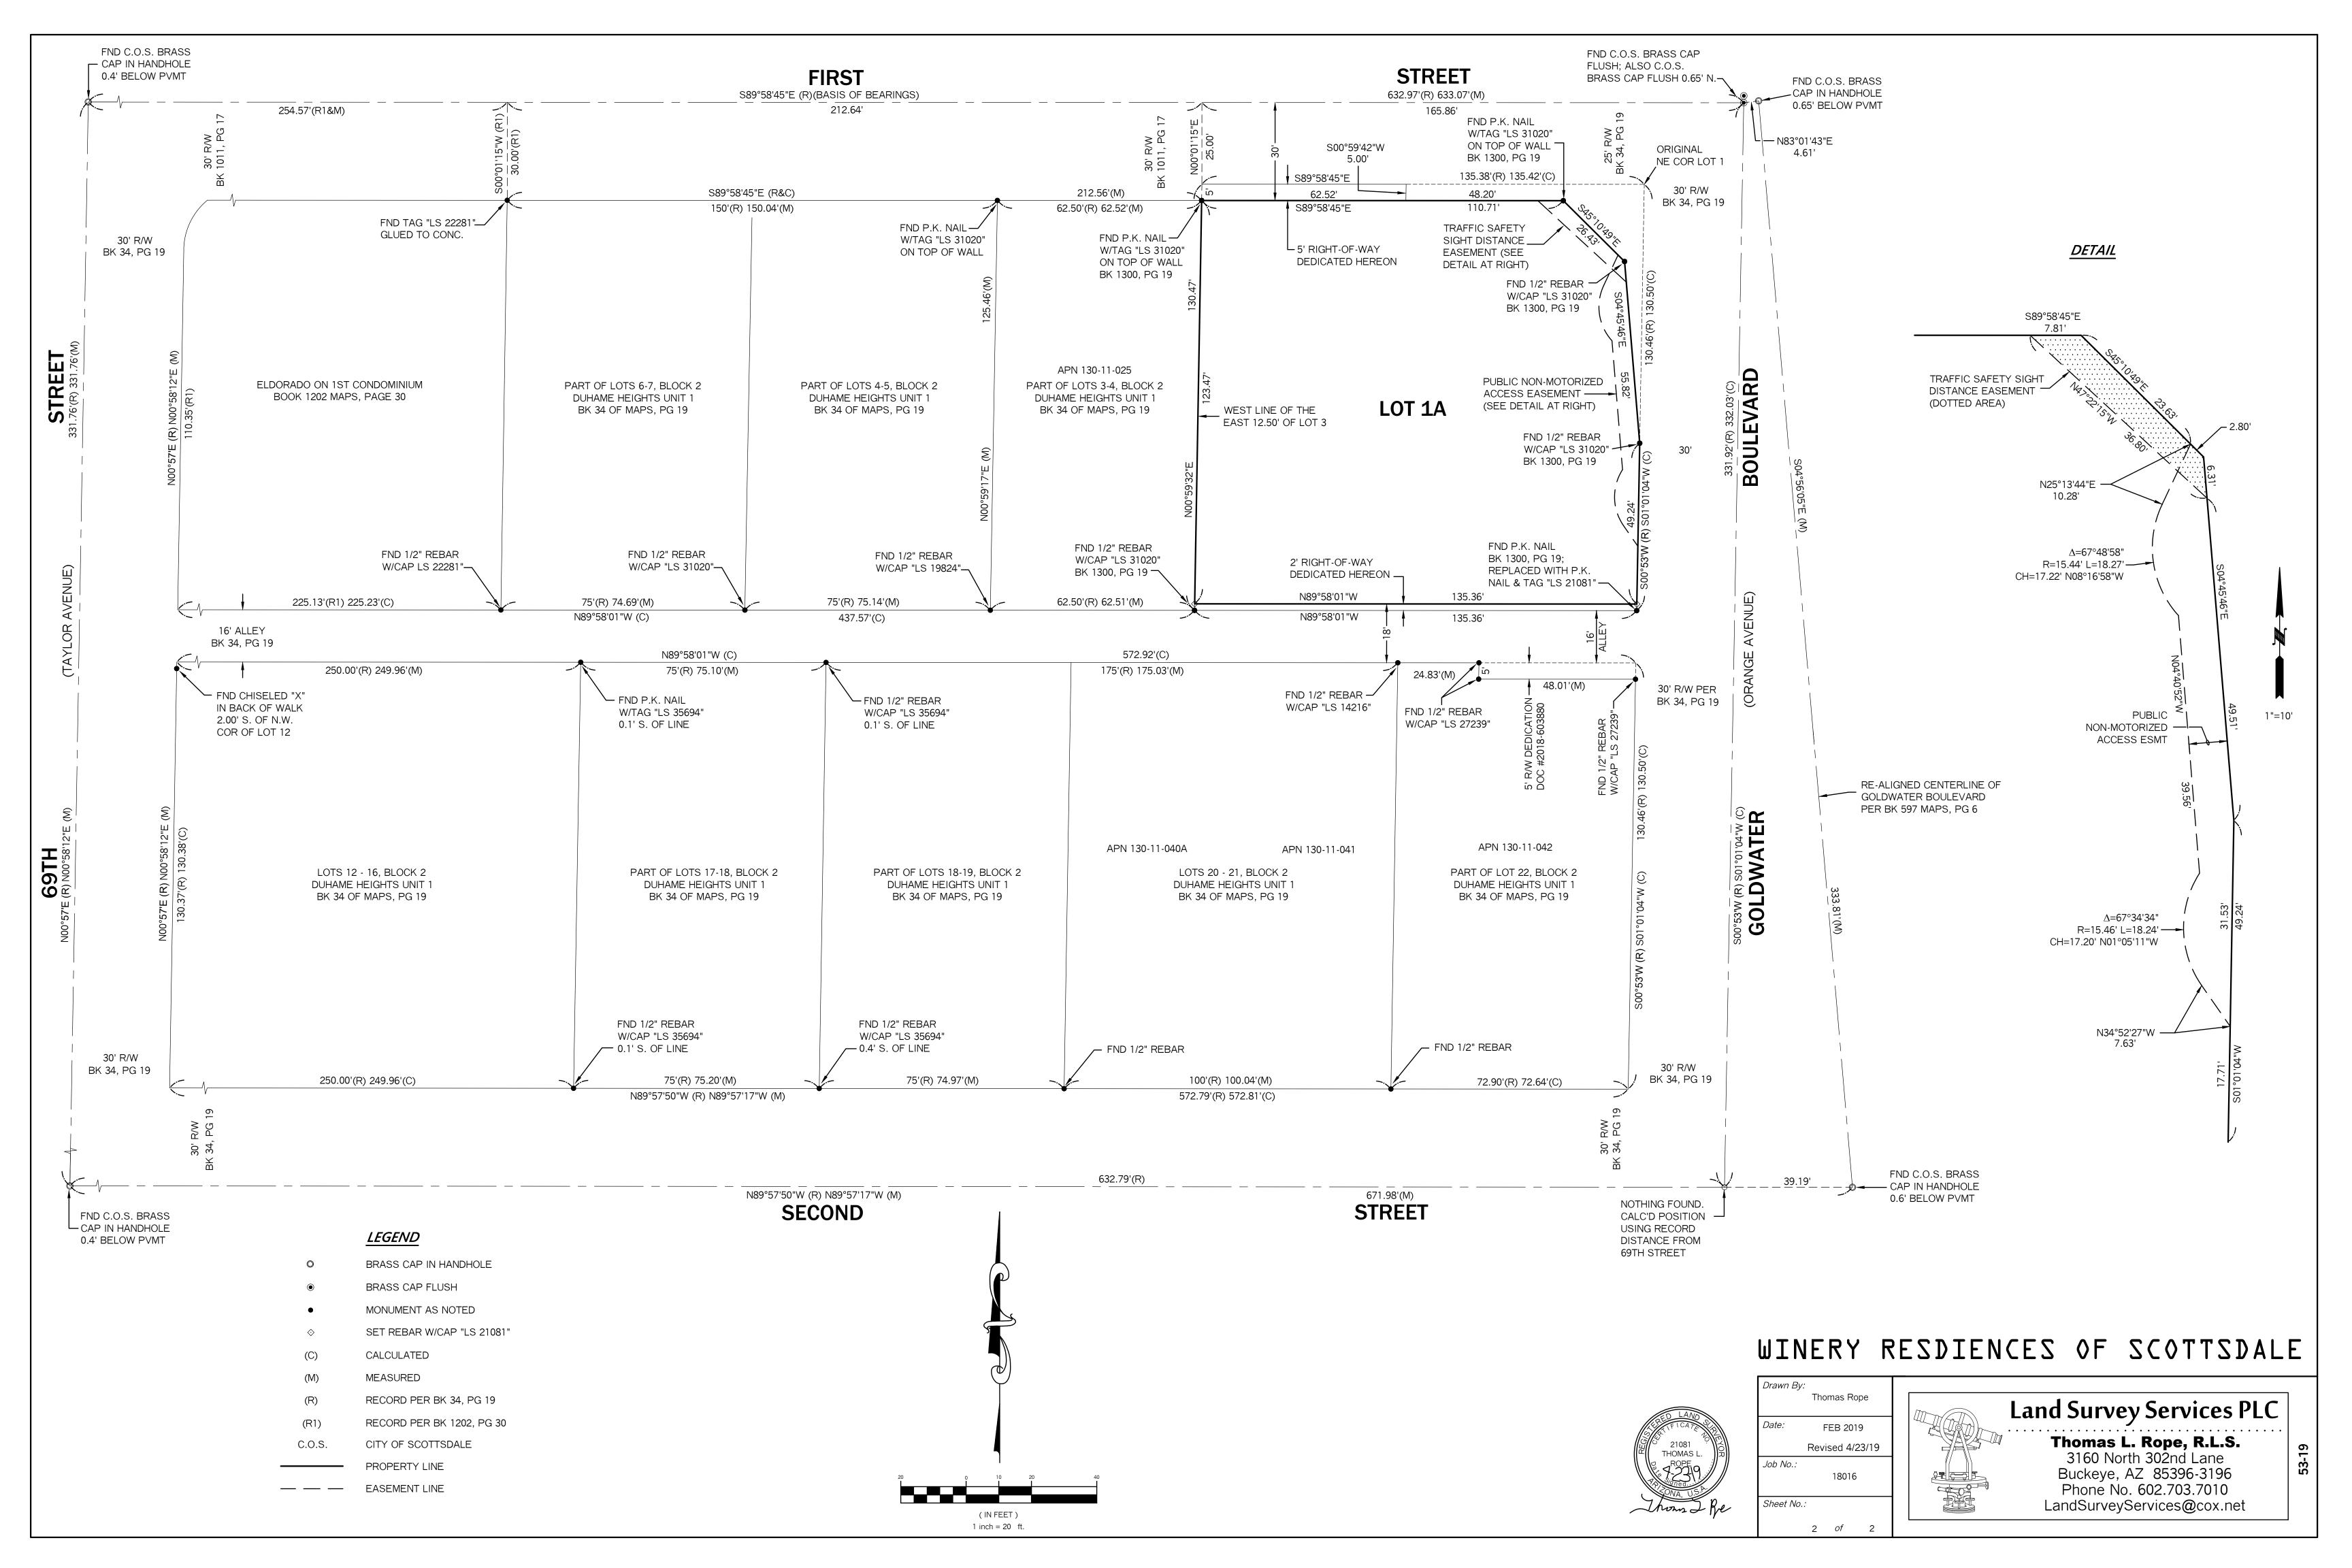





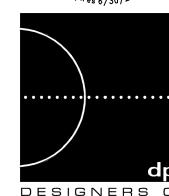

DESIGNERS OF PROGRESSIVE ARCHITECTURE 7272 e indian school rd ste 214 scottsdale, arizona 85251 telephone 480 941 4222 www.dpaarchitects.com

#: Description: Date:		
_		
_		

1054.02

5/6/2019

NOTE REGARDING ALLEY: EXISTING ALLEY SHALL BE RECONSTRUCTED AND REPAVED ALONG THE ENTIRE LENGTH OF THE ALLEY FRONTAGE INCLUDING AREAS BEYOND THE SITE FRONTAGE TO ALLOW FOR TIE-INS TO THE EXISTING ALLEY ON EITHER SIDE OF THE SITE, INCLUDING AN INVERTED CROWN TO IMPROVE DRAINGE, AND ADA ACCESSIBLE PEDESTRIAN CROSSING. SEE THIS SHEET FOR GRADES.

PRELIMINARY GRADING PLAN

Bowman

PLOT DATE 5/6/2019 3:14:07 PM

EX CMU WALL —

130-11-025 D3LLC

BOUNDARY LINE —

— END OF

3' CONCRETE — VALLEY GUTTER

130-11-041

WORTHINGTON CHAD

RONALD

GRADING BY CIVIL PLANS

SEE NOTE ——— REGARDING THE

ALLEY

1ST STREET

FF=61.05

CONCRETE

Sy −CONCRETE

ASPHALT

PENDING

BOUNDARY LINE -

FS FINISHED SURFACE
ES EXISTING SURFACE
EP EXISTING PAVEMENT
TC EXISTING TOP OF CURB
CL CENTERLINE
PL PROPERTY LINE
ESMT EASEMENT
FF FINISHED FLOOR
CMU CONCRETE MASONRY UNIT
R/W RIGHT-OF-WAY
B/C BACK OF CURB

**LEGEND** 

SCALE: 1"=10'

LINE TABLE


NO. DIRECTION LENGTH


STREET

GOLDWATE

D

EX B/C

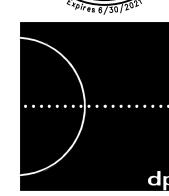

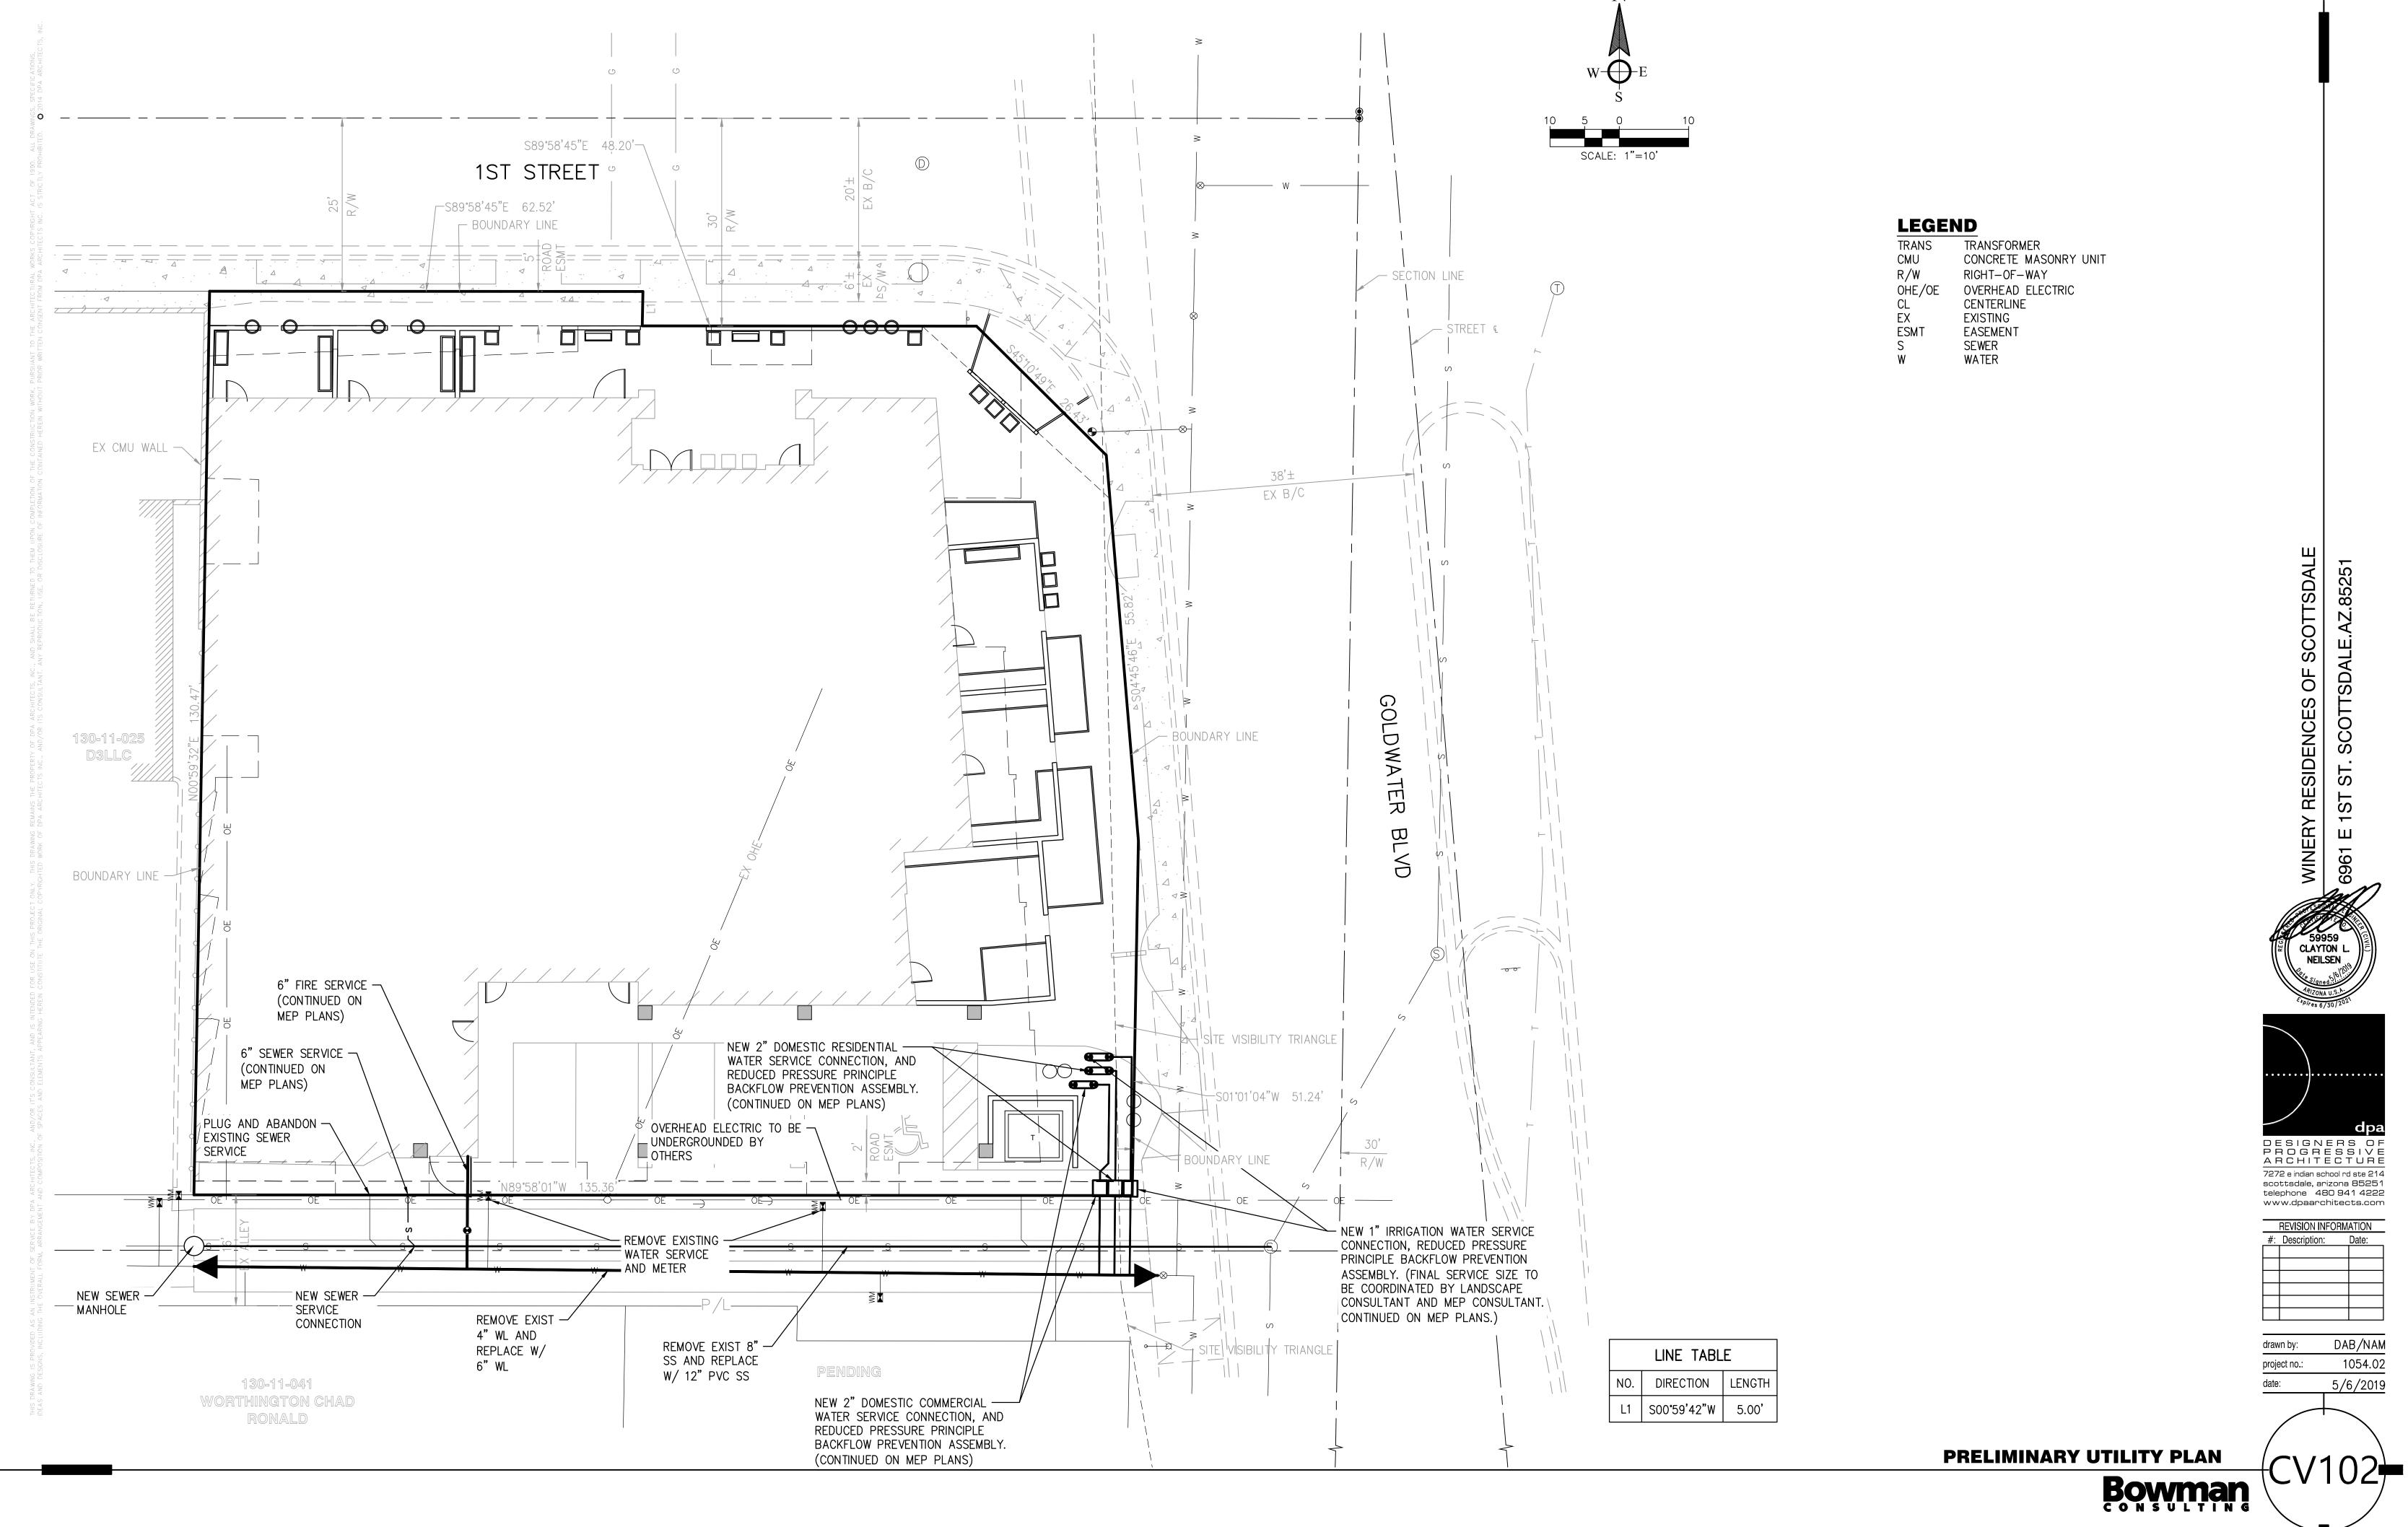


272 e indian school rd ste 214

REVISION INFORMATION

05/06/19

AS100 =

: Description:

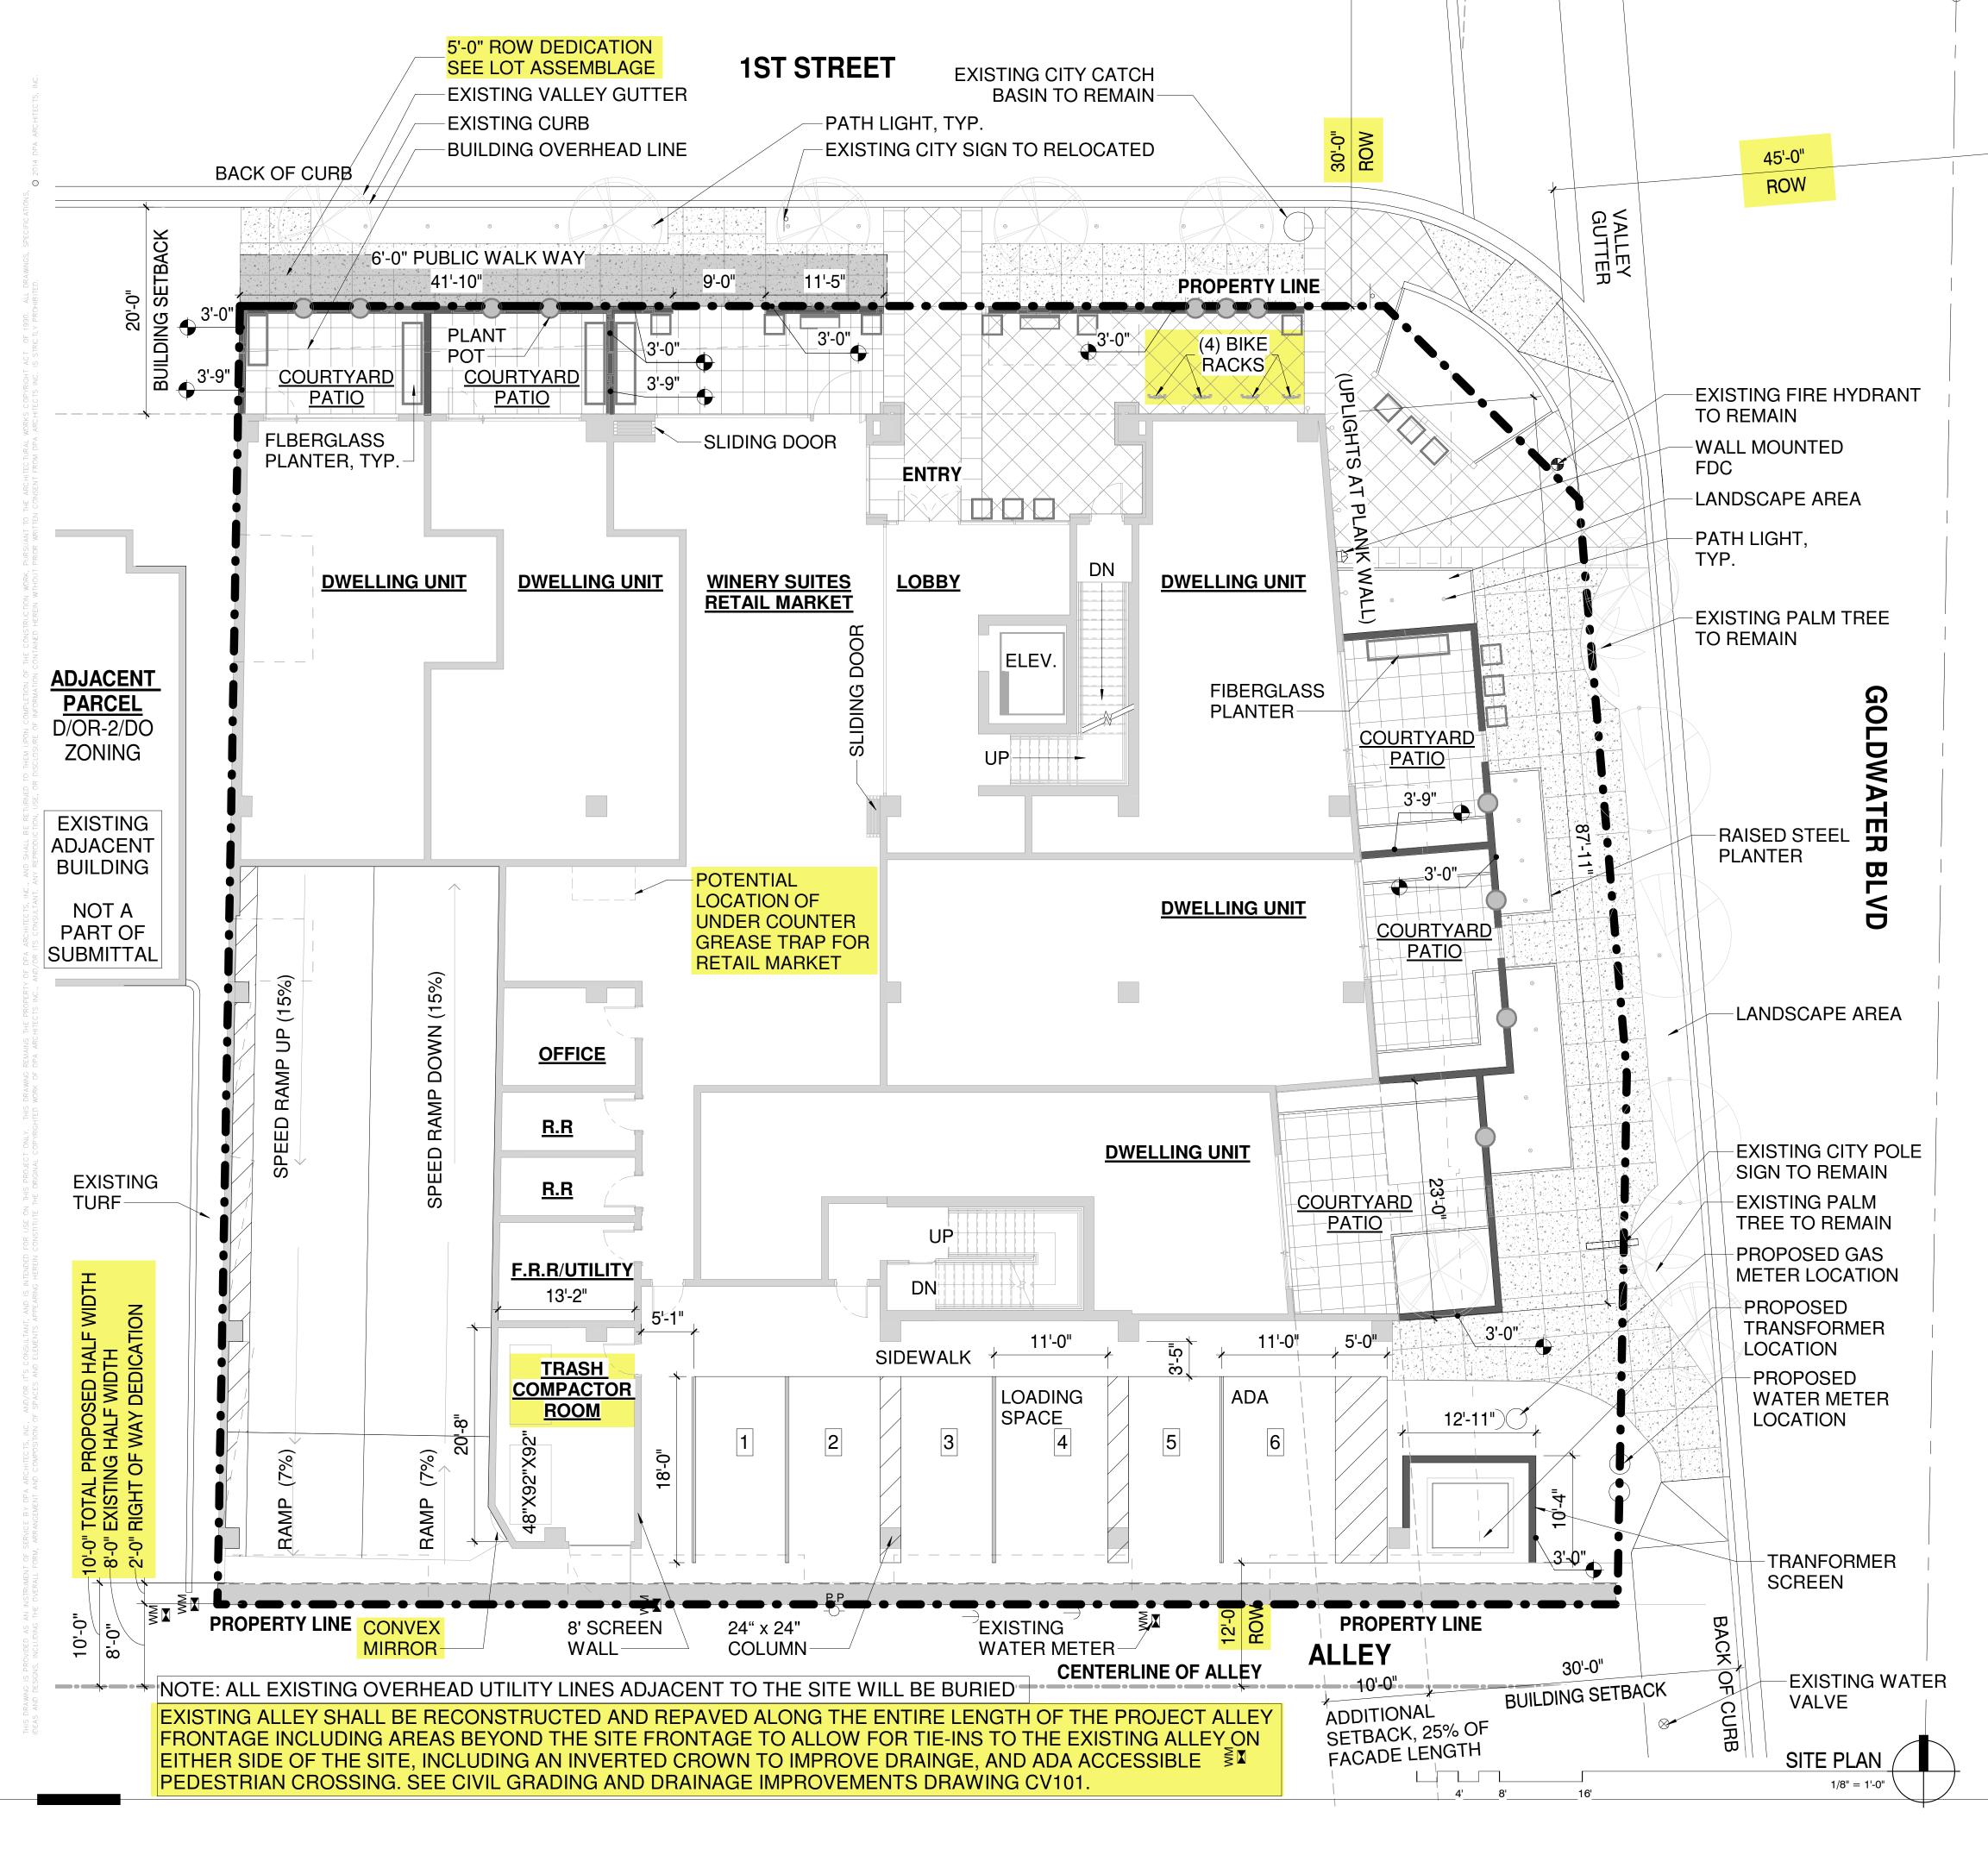

### **PROJECT DATA**

**CURRENT ZONING:** PARCEL 1:

DOWNTOWN OVERLAY

6961 D/OR-2/DO

PARCEL 2:

DMU-2:

CENTRAL BUSINESS DOWNTOWN OVERLAY **BUILDING HEIGHT LIMITATION: 36'-0"** 

6951 C-2/DO **REZONING CLASSIFICATION:** 

DOWNTOWN MULTIPLE USE TYPE 2 AREA, SINGLE PARCEL

**GROSS LOT AREA** (TO HALF STREET & ALLEY): **NET SITE AREA:** 

27,034 SF 16,862 SF

**ALLOWED DENSITY** 

(WITH TYPE-2 DMU REZONING)

50 DU / ACRE

**GROSS LOT AREA** 

50 DU / ACRE X 0.62 ACRE

= 31.03 DU

= 31 DWELLING UNITS

27,034 (0.62 ACRE)

**PROPOSED GFAR** 

(AS DEFINED BY COS ZONING ORDINANCE 3.100):

NONRESIDENTIAL FLOOR AREA(1,645)

GROSS LOT AREA (17,034)

= 0.096

**BUILDING FLOOR AREA** 

(AS DEFINED BY COS ZONING ORDINANCE 3.100): STREET LEVEL: 8,045 SF 11,837 SF LEVEL 2: 11,712 SF LEVEL 3: **ROOF LEVEL** 4,011 SF **SUBTOTAL:** 35,605 SF

UNDERGROUND GARAGE: 16,288 SF 51,884 SF TOTAL:

**AREA OF USE BREAKDOWN: WINERY SUITES RETIAL MARKET:** 1,645 SF (INCLUDES RESTROOMS) STREET LEVEL DEWLLING UNITS: 4,347 SF 8,826 SF 2ND LEVEL DWELLING UNITS: 3RD LEVEL DWELLING UNITS: 9,015 SF 3,086 SF **ROOF LEVEL DWELLING UNITS:** 

**COMMON AREA USE BREAKDOWN:** 

PARKING GARAGE 15,658 SF STREET LEVEL (LOBBY, STAIRS, ELEVATOR, UTILITY ROOMS) 1,050 SF 2ND LEVEL 1,455 SF (STAIRS, ELEVATOR, IDF CLOSET, SHAFT) 3RD LEVEL (STAIRS, ELEVATOR, IDF CLOSET, SHAFT) 1,455 SF **ROOF LEVEL** (POOL DECK, STAIRS, HVAC AREA) 6,520 SF

**BUILDING HEIGHT ALLOWED** (DMU-2 REZONING): PROPOSED BUILDING HEIGHT:

51'-7' 30'-0" **SETBACKS:** 20'-0" NORTH GOLDWATER BLVD (FROM CURB): 10'-0" 1ST STREET (FROM CURB): ALLEY (FROM CENTERLINE):

STEPBACKS:

30'-0" TO 45'-0" HEIGHT: 45'-0" AND ABOVE:

1:1 INCLINE STEPBACK 2:1 INCLINE STEP BACK

PLEASE SEE AS100.1 SITE PLAN WORKSHEET FOR MORE PARKING AND BIKE REQUIRED AND PROVIDED CALCULATION

SITE PLAN

REZONING/DR DEVELOPMENT SUBMITTAL

# **VICINITY MAP**



# **PROJECT DATA**

<b>DWELLING UNIT COUNT:</b> STREET LEVEL:	5
2ND LEVEL:	11
3RD LEVEL:	11
ROOF LEVEL:	4
TOTAL	31

### **RESTAURANT / RETAIL AT GROUND LEVEL:**

MERCANTILE/RETAIL:	1,506 SF

### PARKING CALCULATIONS

**REQUIRED**: MERCANTILE/RETAIL 1,506 SF (1,506 SF- 4,000 SF SITE VESTEDCREDITS) /350 = 0 **0** SPACES

DWELLING UNITS: 1 BEDROOM UNITS (31X1) = **31** SPACES 1 SPACE PER UNIT

# **TOTAL REQUIRED:**

PROVIDED:

UNDERGROUND:

25 SPACES SURFACE: 6 SPACES

**31** SPACES

2 SPACES

**TOTAL PROVIDED: 31** SPACES

### **ACCESSIBLE PARKING REQUIRED PER SEC.9.105.A**

(1 SURFACE SPACE AND 1 GARAGE SPACE)

2 SPACES ACCESSIBLE PARKING PROVIDED (1 SURFACE SPACE AND 1 GARAGE SPACE) 2 SPACES

# **BIKE PARKING CALCULATIONS**

**REQUIRED**:

PROVIDED ( SURFACE ): 4 SPACES


**SITE PLAN WORKSHEETS** 

CITY OF SCOTTSDALE REZONING/DR DEVELOPMENT SUBMITTAL 24-ZN-2018 AND 52-DR-2018



AS100.1 —



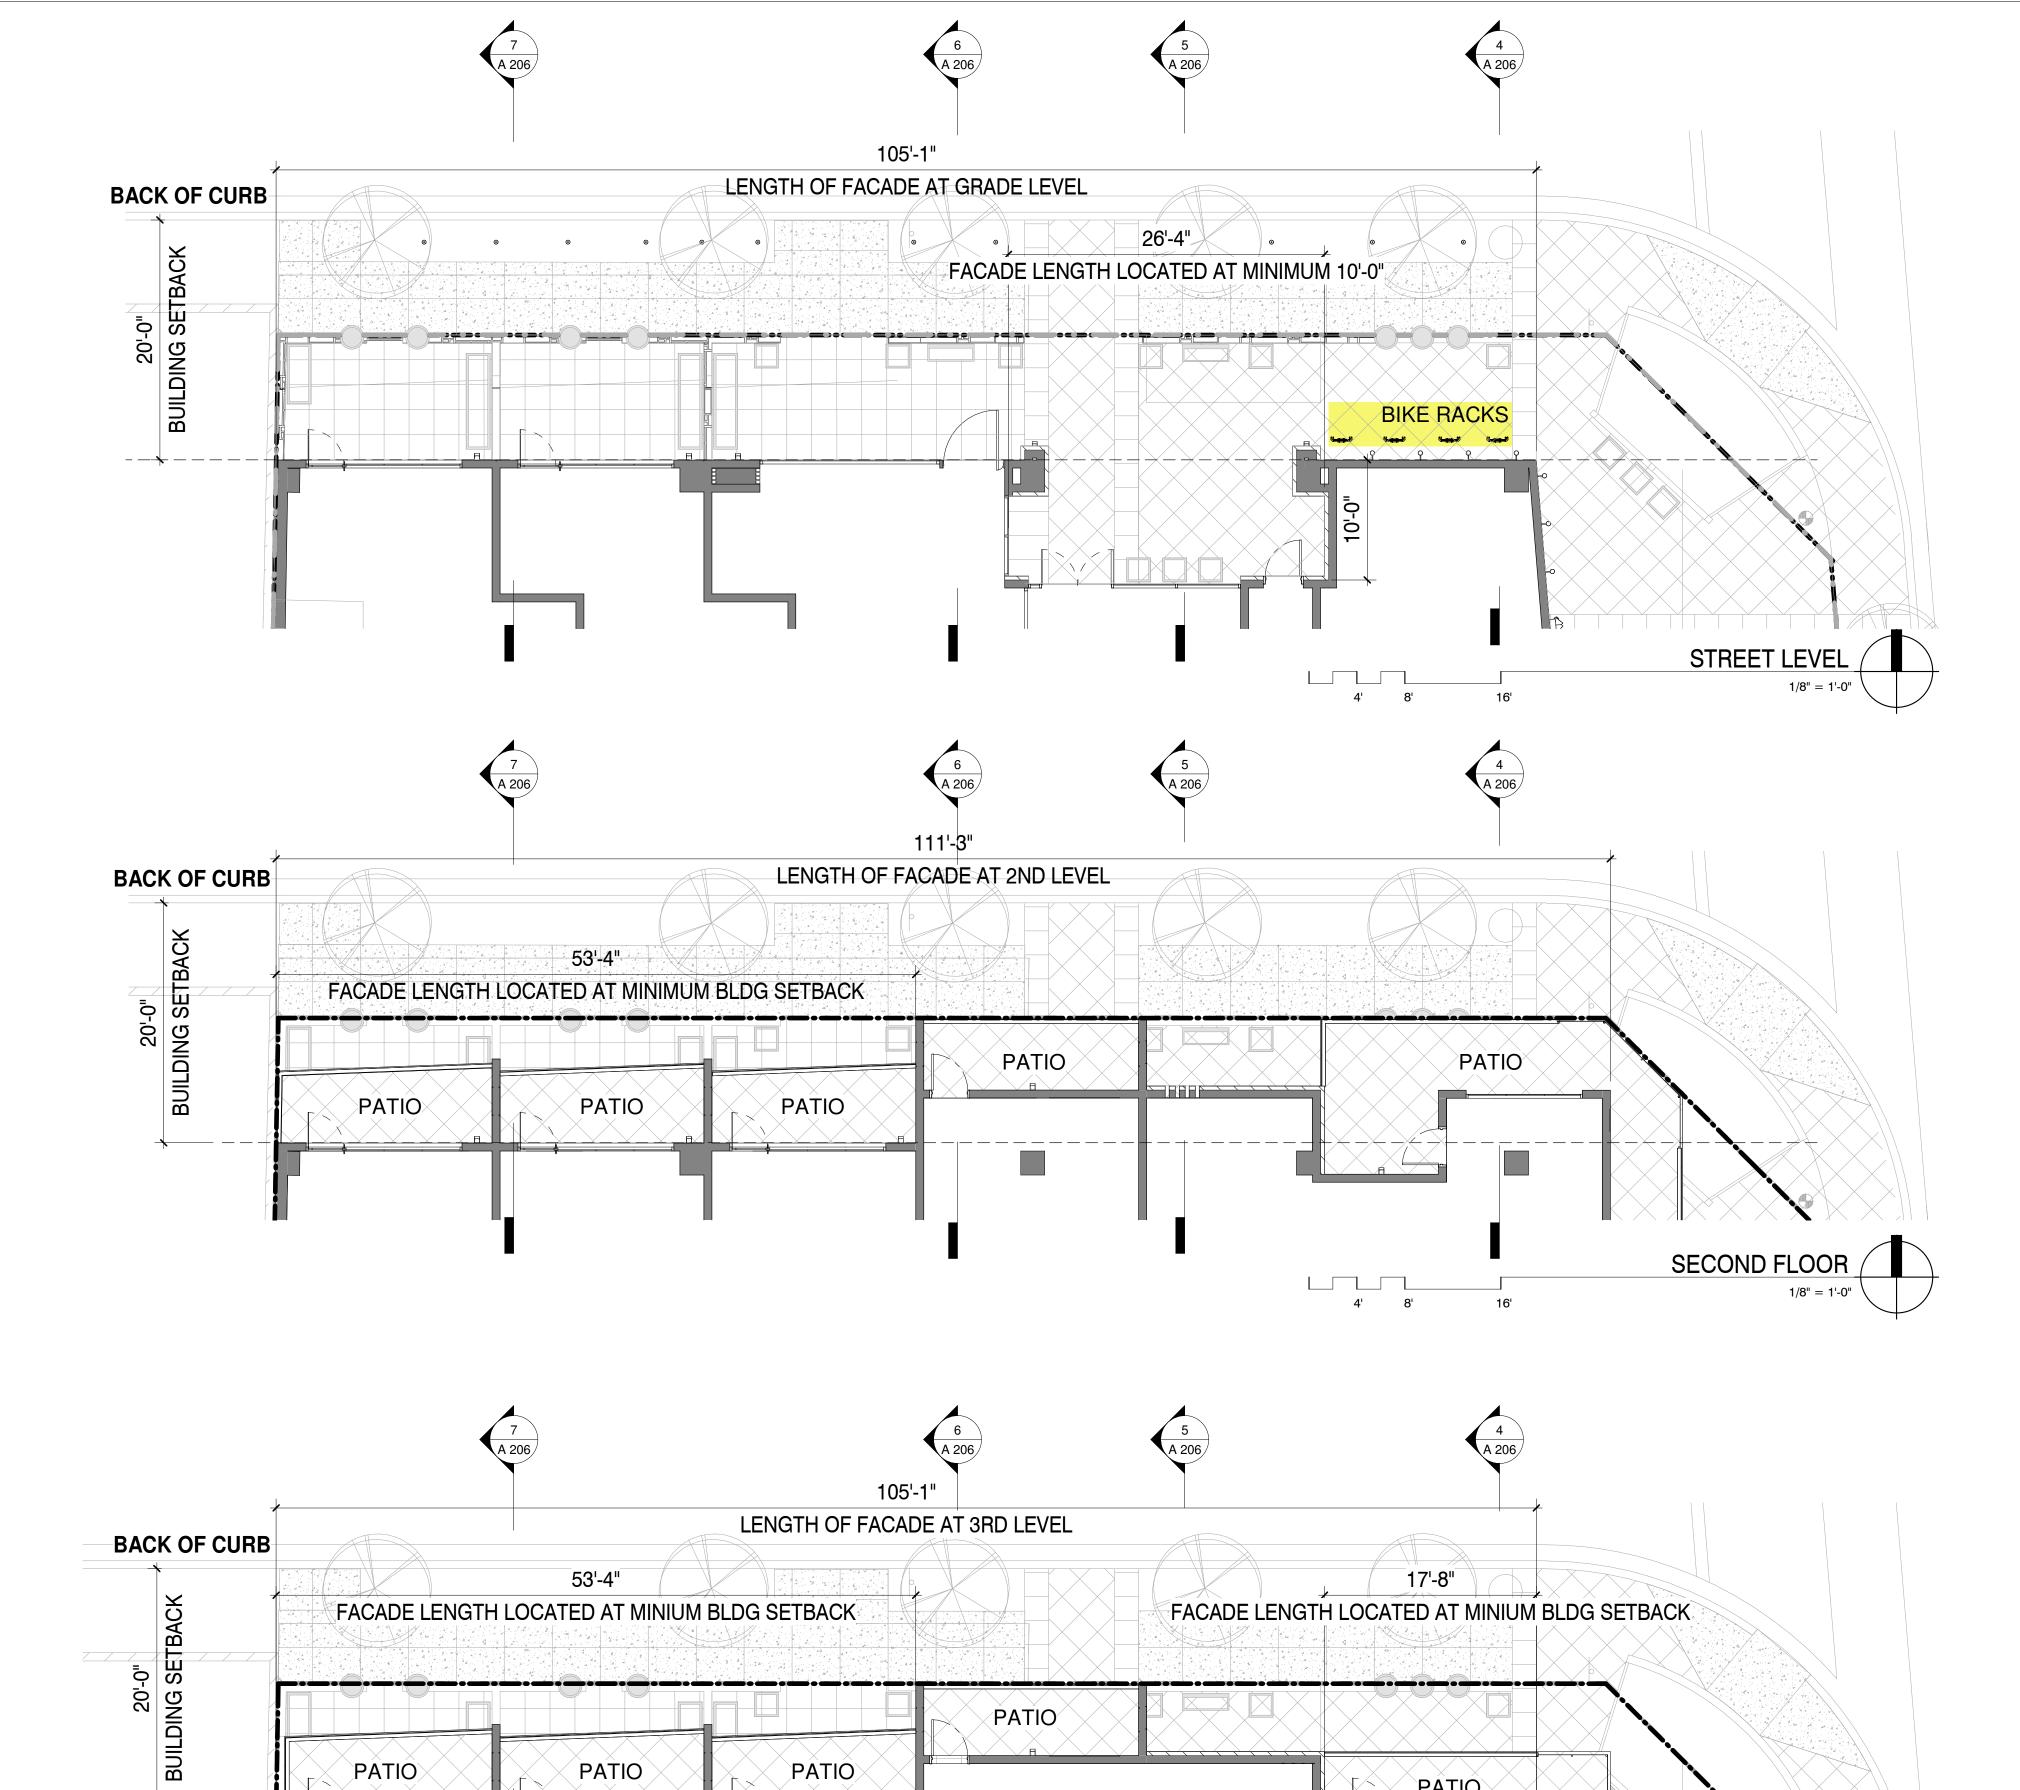

PATIO

4' 8'

THIRD LEVEL /

PATIO

PATIO

PATIO

### **BUILDING LOCATION**

### **1ST STREET**

i) TOTAL LENGTH OF FACADE = 111.4'

FACADE LENGTH LOCATED AT MINIMUM BUILIDNG SETBACK REQUIRED = (111.4' X 25%) = 27.85'

ACTUAL = 62' > 27.85' OK

ii)TOTAL LENGTH OF FACADE AT GRADE LEVEL = 105'

FACADE LENGTH LOCATED AT MINIMUM 10' - 0" FROM AT MINIMIUM BUILDING SETBACK REQUIRED = (105 X 25%) = 26.25'


ACTUAL = 26.33 > 26.25' OK

iii) TOTAL FACADE AREA = 4214 SF

AREA AT MINIMUM BUILDING SETBACK REQUIRED = (4214X 25%) = 1053.5 SF


ACTUAL = 2148 > 1053.5 OK

PLEASE SEE ELEVATION WORKSHEETS A202/A203 FOR AREA CALCULATION

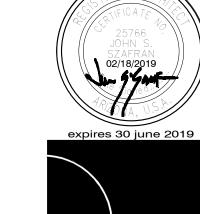



REVISION INFORMATION

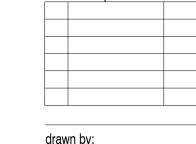

AS100.2 <del>-</del>

**STREET FRONTAGE ILLUSTRATION - 1ST STREET** 


CITY OF SCOTTSDALE REZONING/DR DEVELOPMENT SUBMITTAL 24-ZN-2018 AND 52-DR-2018

PLEASE SEE ELEVATION WORKSHEETS A202/A203 FOR AREA CALCULATION DETAILS

**BUILDING LOCATION** 

**EAST ELEVATION - GOLDWATER BLVD** 

i) TOTAL LENGTH OF FACADE = 118.08'

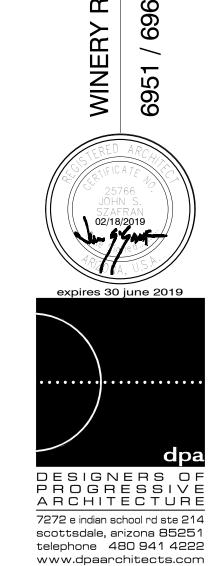


REVISION INFORMATION

AS100.3 —

STREET FRONTAGE ILLUSTRATION - GOLDWATER BLVD

CITY OF SCOTTSDALE REZONING/DR DEVELOPMENT SUBMITTAL 24-ZN-2018 AND 52-DR-2018

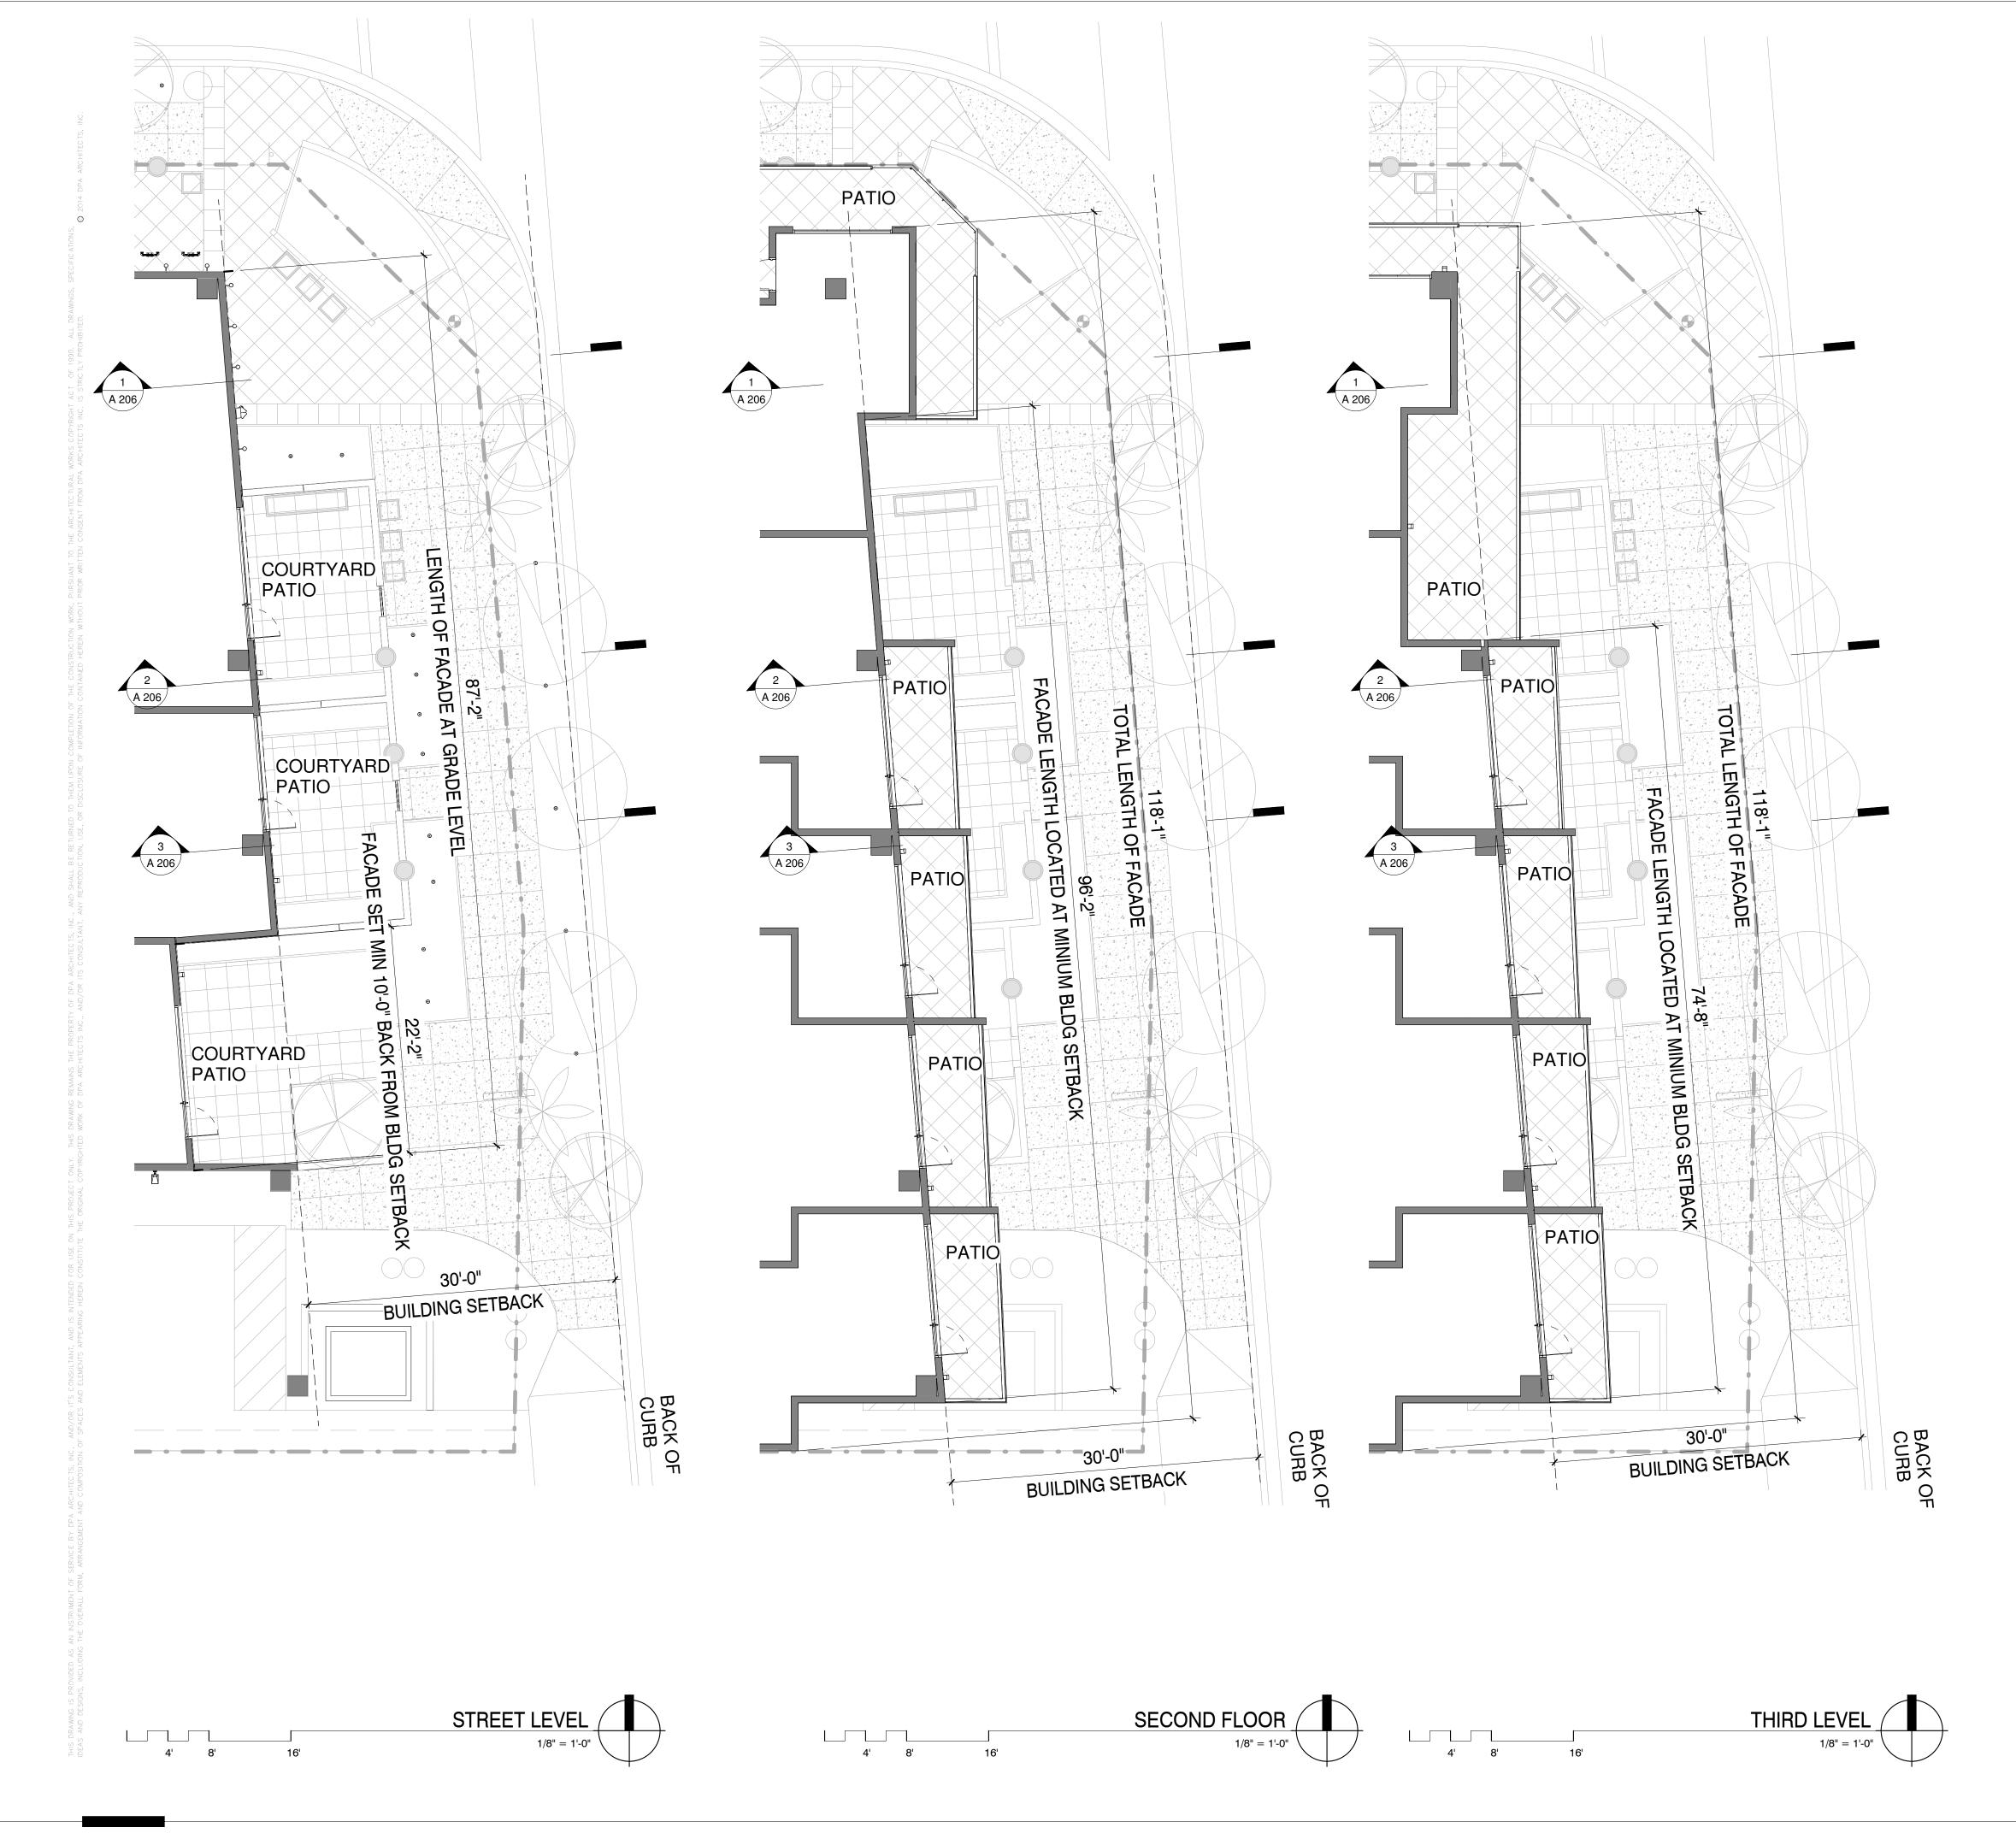



**ESIDENCES OF SCOTTSDALE** 

REVISION INFORMATION
#: Description: Date:

drawn by: YT
project no.: 18024
date: 02/18/19

A 100

FLOOR PLANS - GARAGE LEVEL / STREET LEVEL

CITY OF SCOTTSDALE
REZONING/DR DEVELOPMENT SUBMITTAL
24-ZN-2018 AND 52-DR-2018


DESIGNERS OF PROGRESSIVE ARCHITECTURE 7272 e indian school rd ste 214 scottsdale, arizona 85251 telephone 480 941 4222 www.dpaarchitects.com REVISION INFORMATION #: Description: Date: drawn by: 02/18/19 FLOOR PLANS - 2ND LEVEL / 3RD LEVEL A 101 🛨 CITY OF SCOTTSDALE REZONING/DR DEVELOPMENT SUBMITTAL 24-ZN-2018 AND 52-DR-2018

**ESIDENCES OF SCOTTSDALE** 

FLOOR PLANS - ROOF LEVEL / PARAPET LEVEL

CITY OF SCOTTSDALE
REZONING/DR DEVELOPMENT SUBMITTAL
24-ZN-2018 AND 52-DR-2018

## **VICINITY MAP**

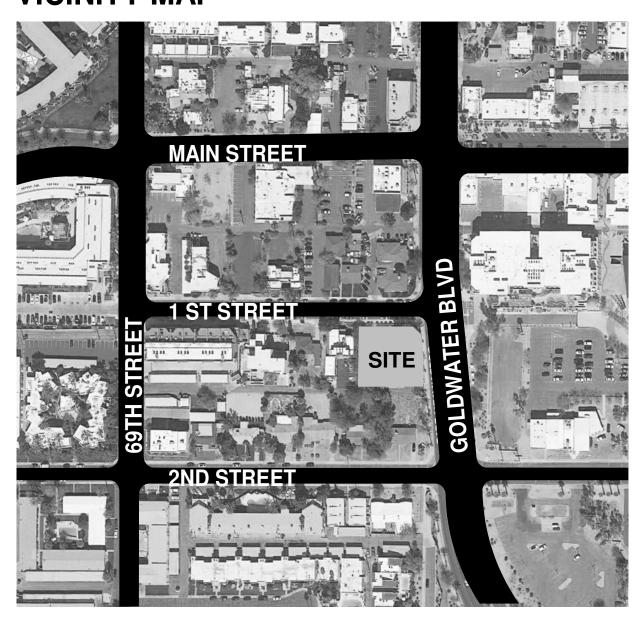

## **PROJECT DATA**

<b>DWELLING UNIT COUNT:</b> STREET LEVEL:	5
2ND LEVEL:	11
3RD LEVEL:	11
ROOF LEVEL:	4
TOTAL	31

## RESTAURANT / RETAIL AT GROUND LEVEL:

IERCANTILE/RETAIL:	1,506 SF

### PARKING CALCULATIONS

REQUIRED:	
MERCANTILE/RETAIL	1,506 SF
(1,506 SF- 4,000 SF SITE \	VESTEDCREDITS)/350 = 0
·	<b>0</b> SPACES

DWELLING UNITS: 1 BEDROOM UNITS (31X1) = **31** SPACES 1 SPACE PER UNIT

## **TOTAL REQUIRED:**

D: 31 SPACES

PROVIDED:

UNDERGROUND: 25 SPACES SURFACE: 6 SPACES

## TOTAL PROVIDED:

ACCESSIBLE PARKING REQUIRED PER SEC.9.105.A (1 SURFACE SPACE AND 1 GARAGE SPACE)

2 SPACES

ACCESSIBLE PARKING PROVIDED
(1 SURFACE SPACE AND 1 GARAGE SPACE) 2 SPACES

### **BIKE PARKING CALCULATIONS**

REQUIRED:

2 SPACES

PROVIDED ( SURFACE ):

4 SPACES

**31** SPACES

		-+
	/	

SITE PLAN WORKSHEETS


CITY OF SCOTTSDALE
REZONING/DR DEVELOPMENT SUBMITTAL
24-ZN-2018 AND 52-DR-2018

WINERY RESIDENCE


WINERY RESIDENCE

STAFFAN

STA

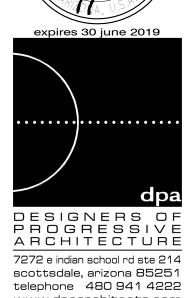

AS100.1 —

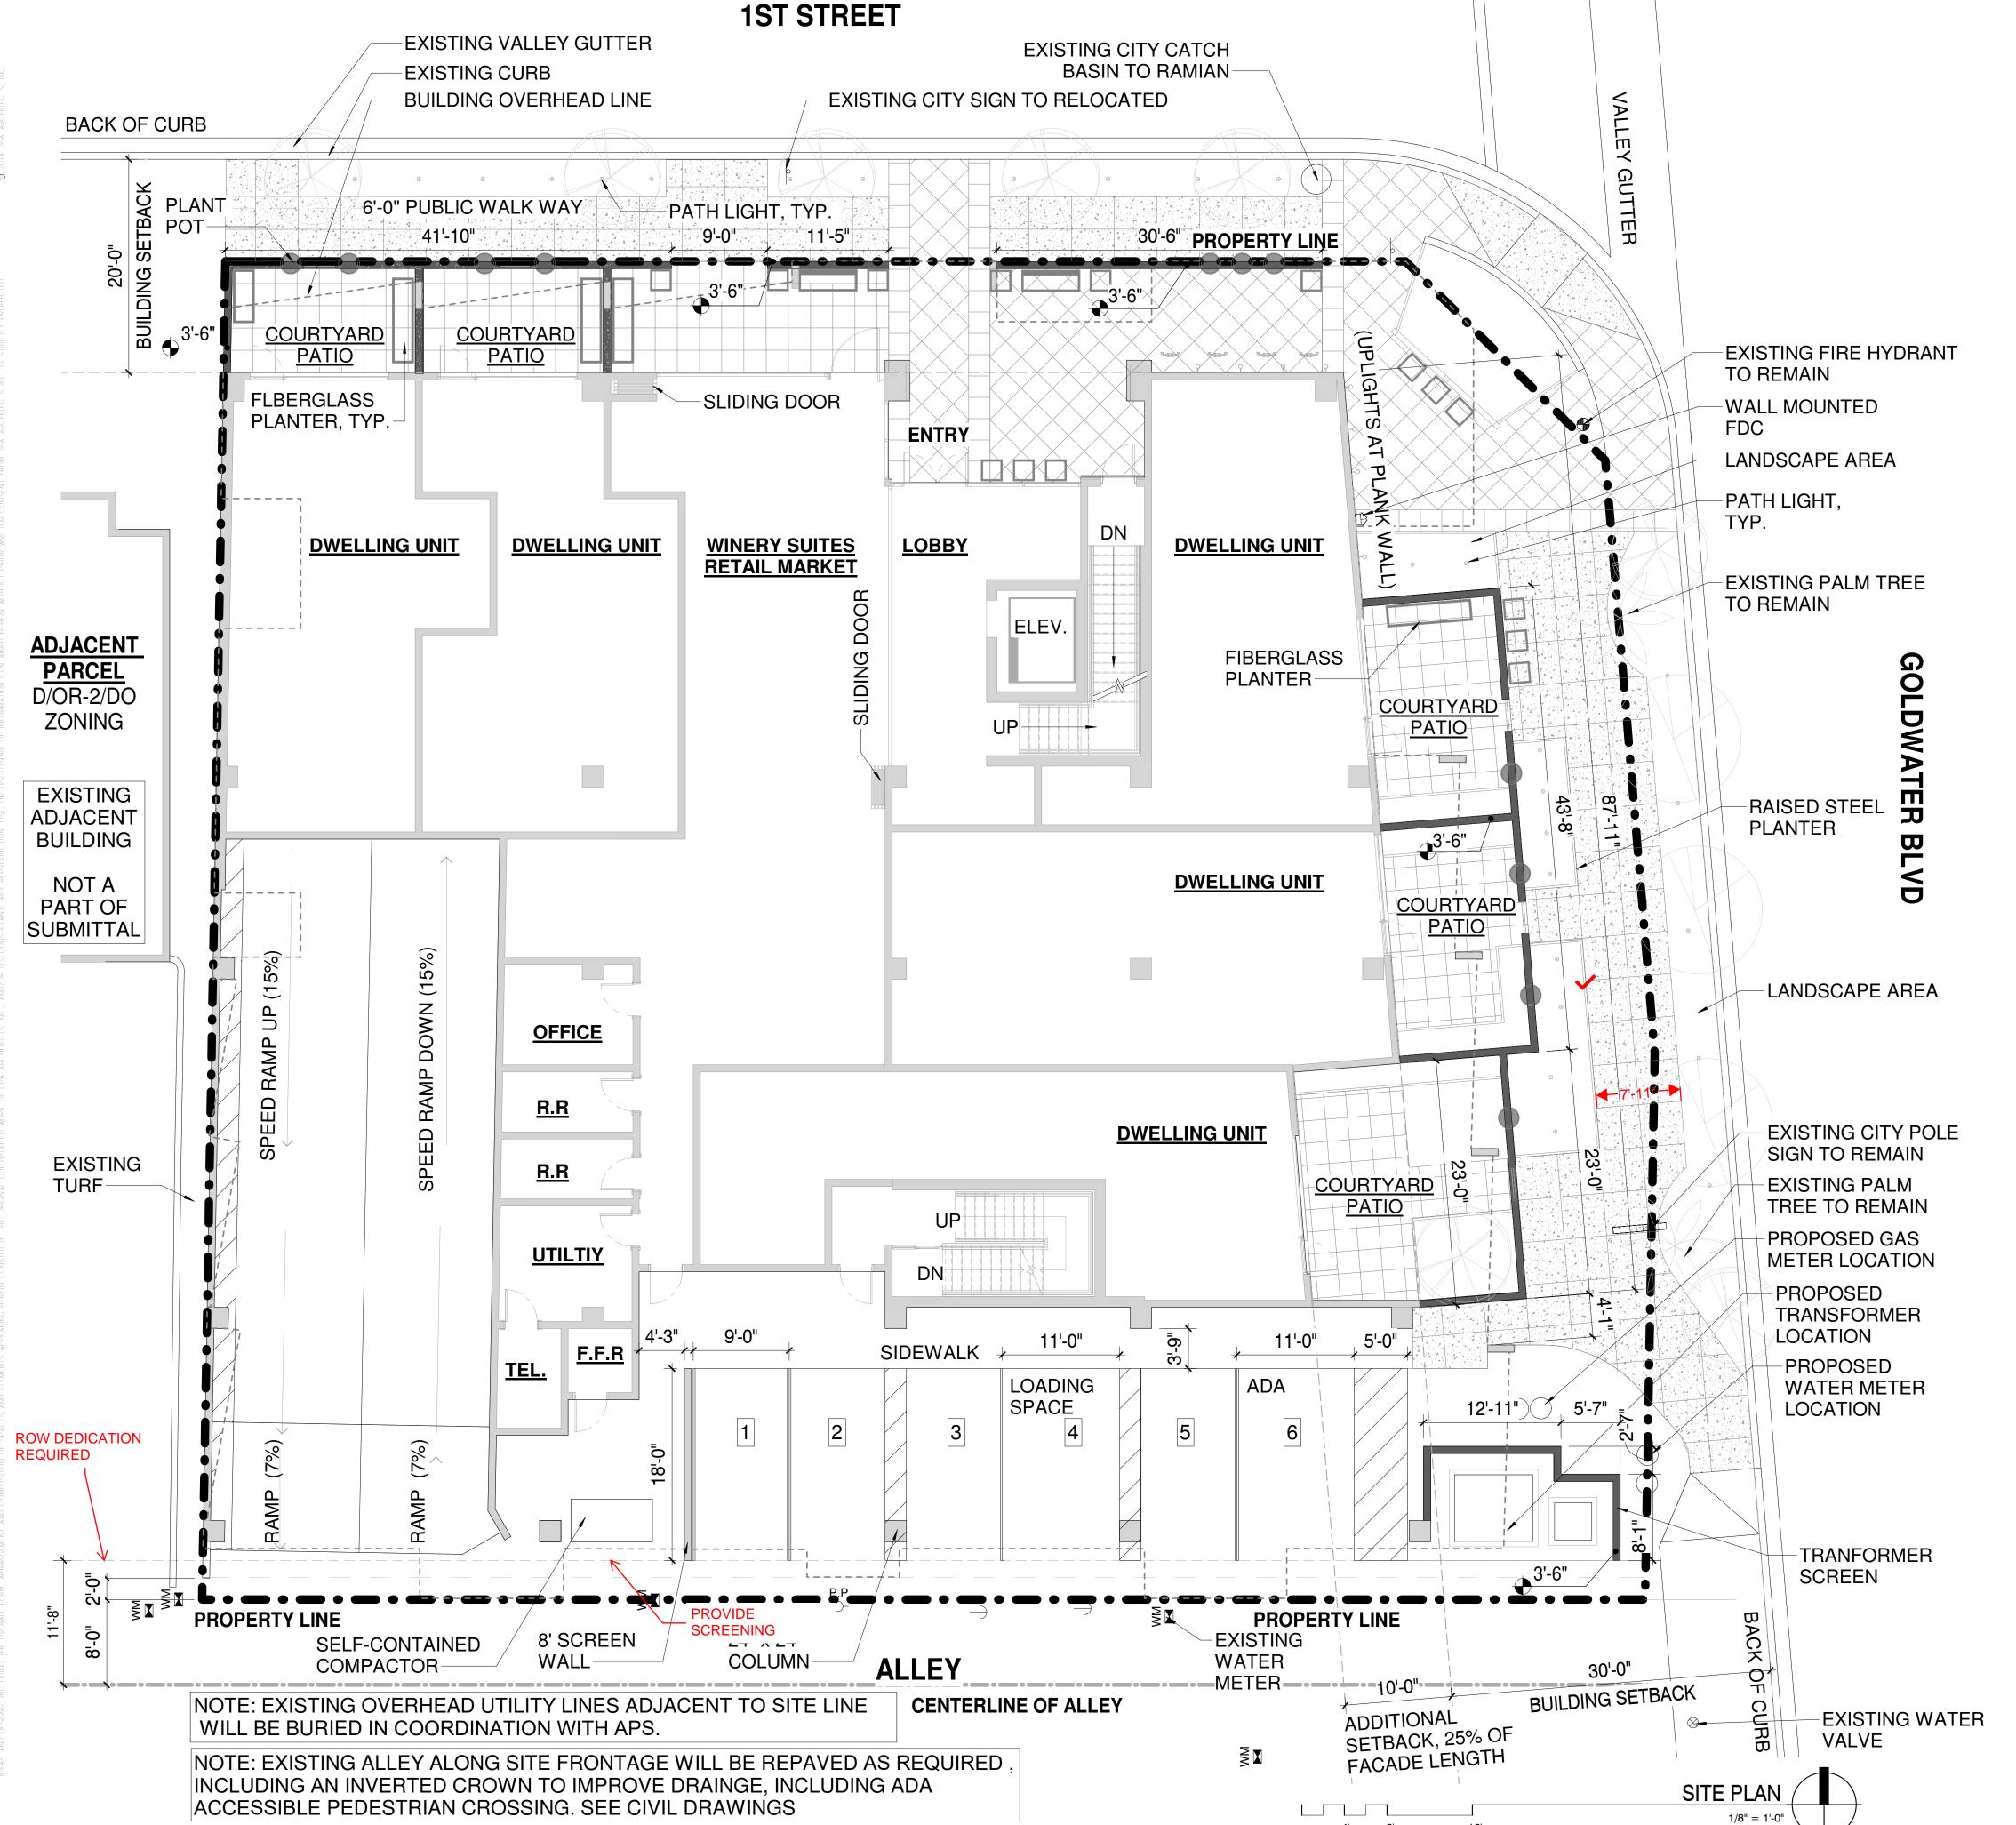

## **PROJECT DATA**

**CURRENT ZONING:** PARCEL 1:

DOWNTOWN OVERLAY

6961 D/OR-2/DO PARCEL 2:

CENTRAL BUSINESS DOWNTOWN OVERLAY **BUILDING HEIGHT LIMITATION: 36'-0"** 

**REZONING CLASSIFICATION:** 

6951 C-2/DO

DOWNTOWN MULTIPLE USE TYPE 2 AREA, DMU-2: SINGLE PARCEL

**GROSS LOT AREA** (TO HALF STREET & ALLEY): 27,034 SF

**ALLOWED DENSITY** 

**NET SITE AREA:** 

(WITH TYPE-2 DMU REZONING)

50 DU / ACRE

**GROSS LOT AREA** 

27,034 (0.62 ACRE)

16,862 SF

50 DU / ACRE X 0.62 ACRE

= 31.03 DU= 31 DWELLING UNITS

PROPOSED GFAR

(AS DEFINED BY COS ZONING ORDINANCE 3.100):

NONRESIDENTIAL FLOOR AREA(1,645)

= 0.096GROSS LOT AREA (17,034)

**BUILDING FLOOR AREA** 

(AS DEFINED BY COS ZONING ORDINANCE 3.100): STREET LEVEL: 8,045 SF LEVEL 2: 11,837 SF 11,712 SF LEVEL 3: **ROOF LEVEL:** 4,011 SF

SUBTOTAL: 35,605 SF **UNDERGROUND GARAGE:** 16,288 SF TOTAL: 51,884 SF

**AREA OF USE BREAKDOWN:** 

WINERY SUITES RETIAL MARKET: 1,645 SF (INCLUDES RESTROOMS) 4,347 SF STREET LEVEL DEWLLING UNITS: 8,826 SF 2ND LEVEL DWELLING UNITS: 3RD LEVEL DWELLING UNITS: 9,015 SF 3,086 SF ROOF LEVEL DWELLING UNITS:

**COMMON AREA USE BREAKDOWN:** 

PARKING GARAGE 15,658 SF STREET LEVEL (LOBBY, STAIRS, ELEVATOR, UTILITY ROOMS) 1,050 SF 2ND LEVEL (STAIRS, ELEVATOR, IDF CLOSET, SHAFT) 1,455 SF 3RD LEVEL (STAIRS, ELEVATOR, IDF CLOSET, SHAFT) 1,455 SF **ROOF LEVEL** (POOL DECK, STAIRS, HVAC AREA) 6,520 SF

66'-0" **BUILDING HEIGHT ALLOWED (DMU-2 REZONING):** 

**SETBACKS:** NORTH GOLDWATER BLVD (FROM CURB): 30'-0" 1ST STREET (FROM CURB): 20'-0" ALLEY (FROM CENTERLINÉ):

STEPBACKS:

30'-0" TO 45'-0" HEIGHT: 1:1 INCLINE STEPBACK 45'-0" AND ABOVE: 2:1 INCLINE STEP BACK

drawn by: 02/18/19


REVISION INFORMATION

AS100 =

#: Description:

**SITE PLAN** 

CITY OF SCOTTSDALE REZONING/DR DEVELOPMENT SUBMITTAL 24-ZN-2018 AND 52-DR-2018

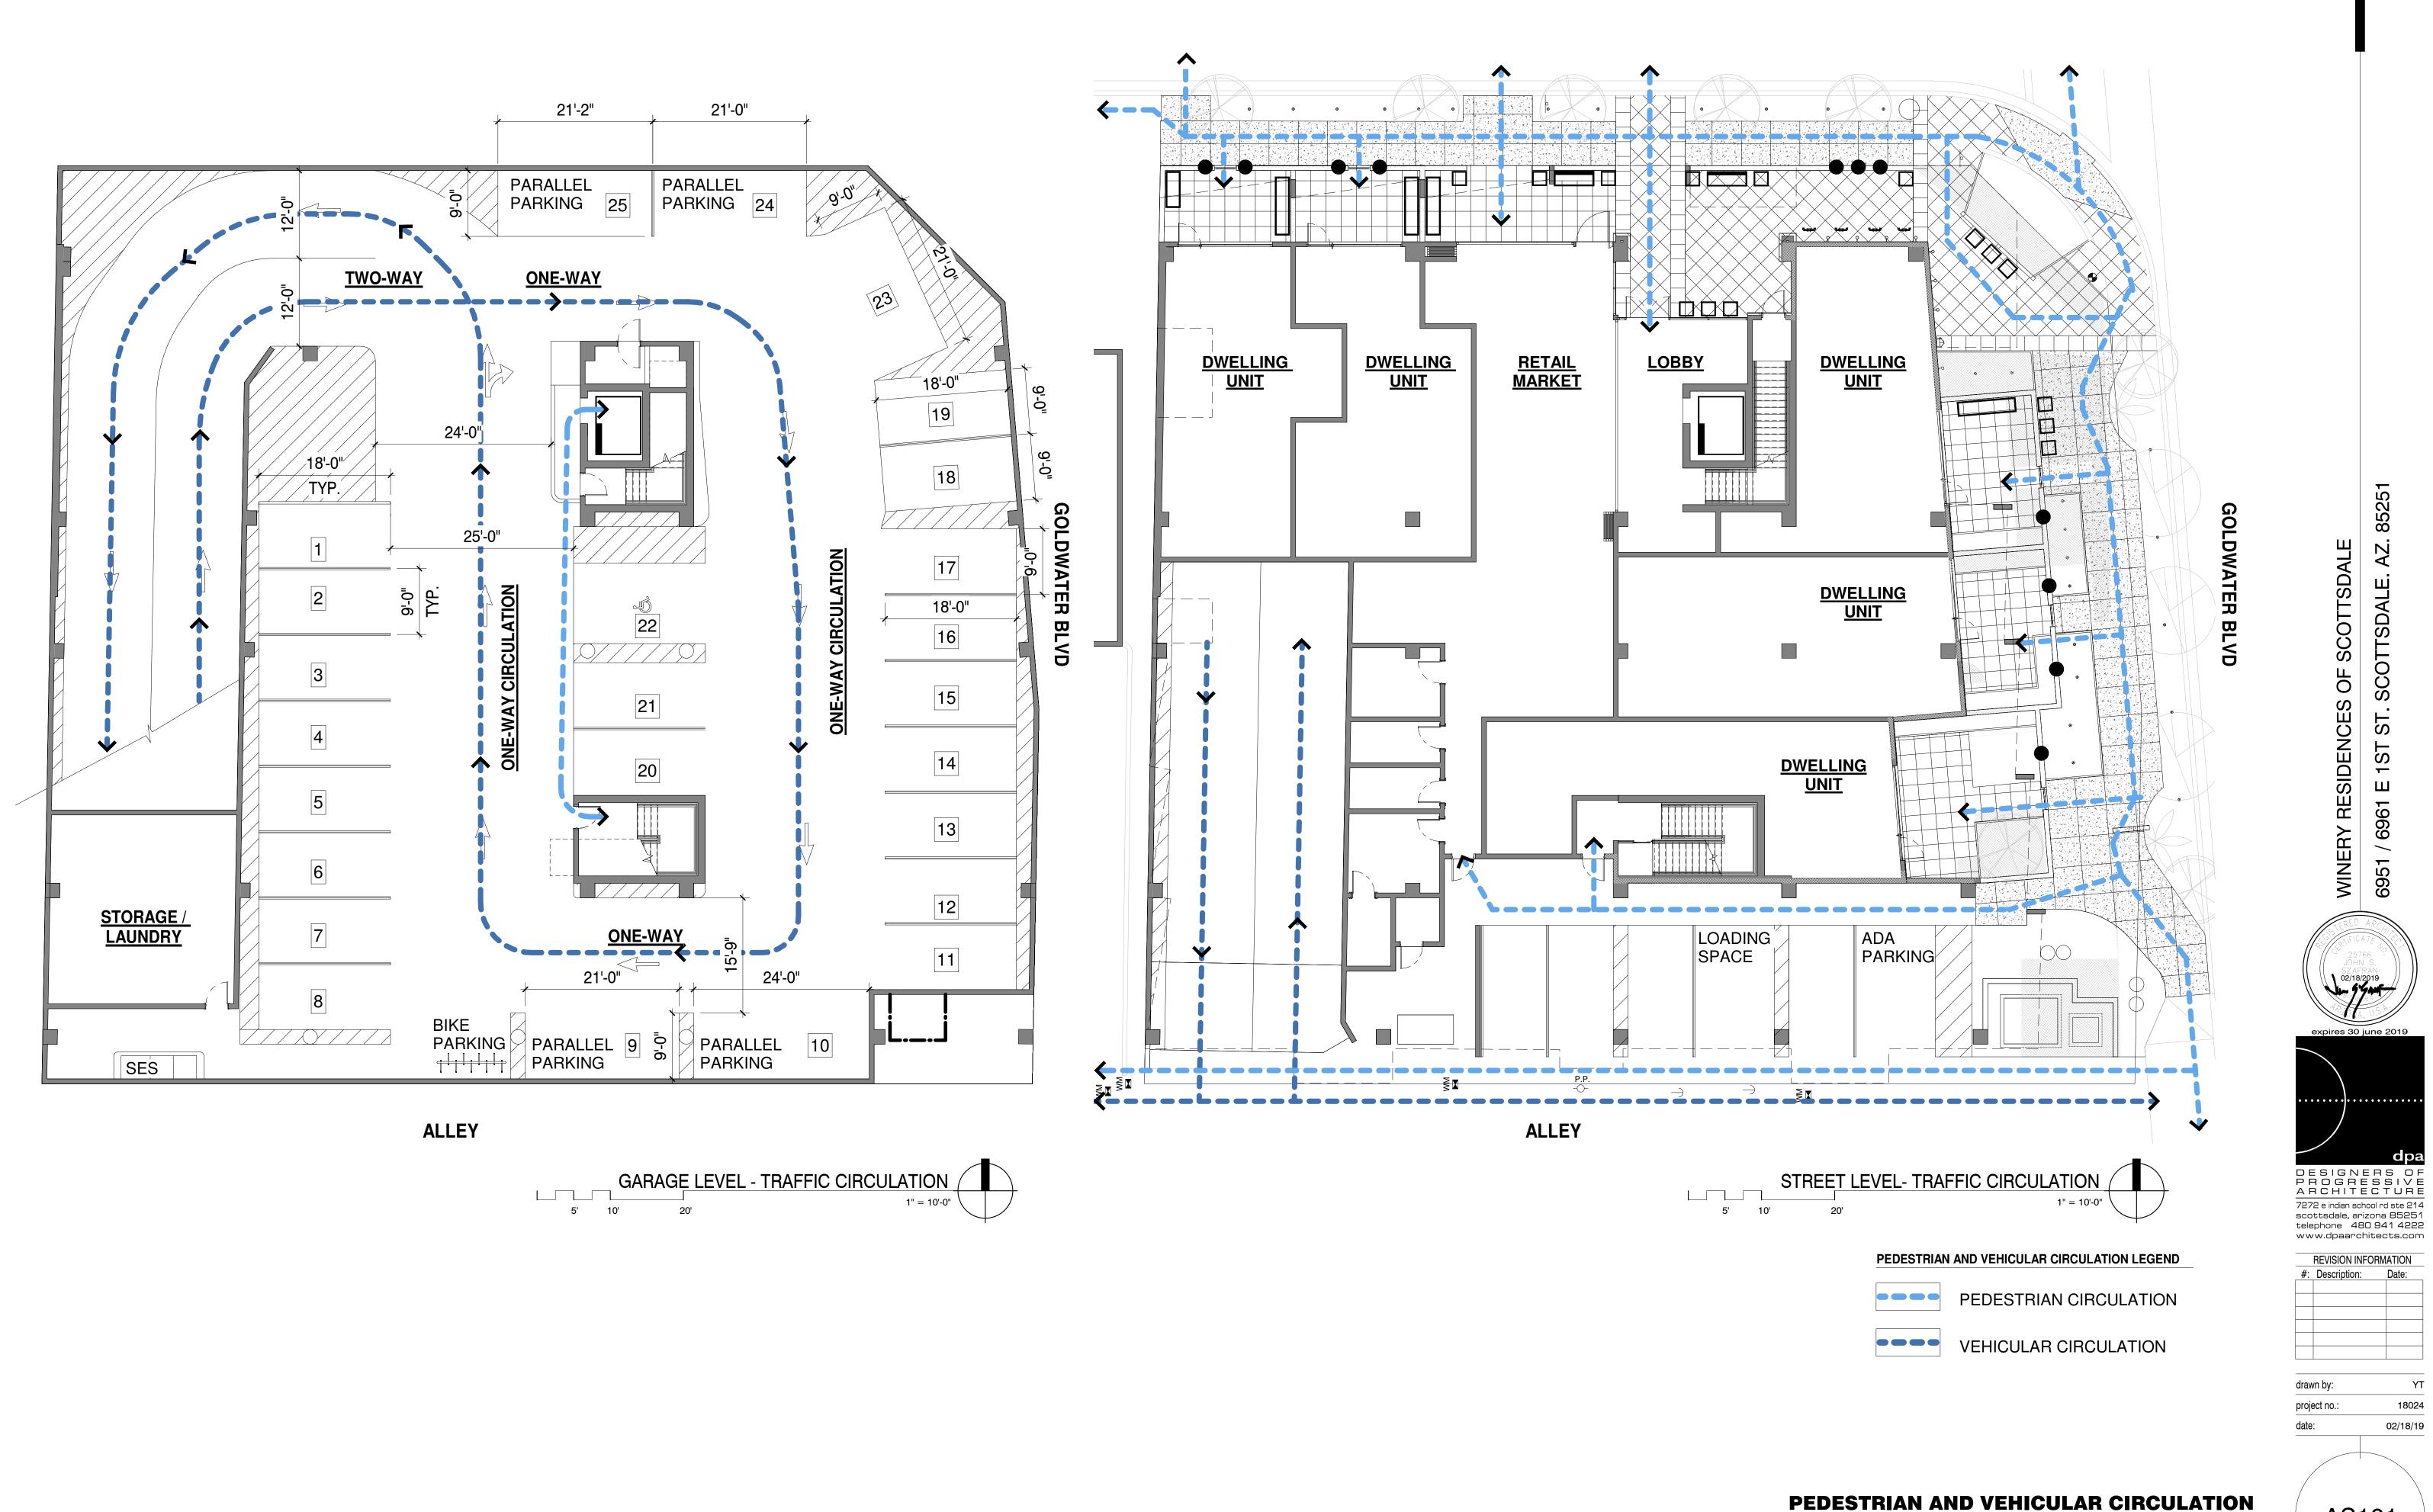

REZONING/DR DEVELOPMENT SUBMITTAL


ESIDENCES OF SCOTTSDALE

REVISION INFORMATION

02/18/19

AS101 —



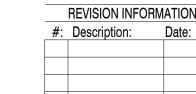

drawn by:	
project no.:	1
date:	02/1

AS102 -

**EXTERIOR LIGHTING SITE PLAN** 

CITY OF SCOTTSDALE REZONING/DR DEVELOPMENT SUBMITTAL 24-ZN-2018 AND 52-DR-2018

LIGHTING FIXTURE SCHEDULE

C-AR-FS-20-LED-391 TEKA LIGHTING

C-CAF-3-LED-E65-W TEKA LIGHTING

C-PNF-6"-LED-E65- TEKA LIGHTING

C-HLP-12"-C-LED-E7 TEKA LIGHTING

BPM-SD12-LED-X84- TEKA LIGHTING

iCUZZINI

**MODEL** 

FL-A9-BP-12-B-360S

MFL-A9-BP-12-11-C-

DM-LED-E10-AQW LITON

POWER CANOPY

BP-S-PT-D23-MT

iTEKA LED

-BP-WHT-120

**MANUFACTURER** 

LAMP

10W LED

8W LED

3W LED

20W LED

3W LED

ENTRY

3000 K

3000 K

3000 K

3000 K

3000 K

3000 K

**DESCRIPTION** 

MOUNTED AT 7' TO CENTER OF FIXTURE, AT PATIO AND

EXTERIOR WALL MOUNTED DOWNLIGHT SINGLE HEAD

FULLY ADJUSTABLE DIRECTIONAL FLOODLIGHT,

SINGLE HEAD FULLY ADJUSTABLE DIRECTIONAL

FLOODLIGHT WITH PAR30 LED RETROFIT LAMP,UP

12" STEM HEIGHT BOLLARD LIGHTING FIXTURE AT

FLOODLIGHT INTENDED FOR USE WITH LED LIGHT SOURCES, WALL MOUNTED AT 7'6"TO CENTER OF

NEW CONSTRUCTION HOUSING, 3000K, WHITE

EXTERIOR RECESSED LED PUCK LIGHT, PINHOLE TRIM,

10W LED ARCADE SERIES 20" EXTERIOR WALL SCONCE, WALL

MOUNTED 8'6" TO CENTER OF FIXTURE

LANDSCAPE AND PATHWAY

PINHOLE, BLACK REFLECTOR.


FIXTURE AT VIEWING DECK

23W LED 6' HEIGHT POLE MOUNT SOLID STATE LIGHTING

LIGHT AT PLANK WALL AND STONE TOWER

FIXTURE, AT PARKING AND MECH ROOM

TYPE MARK

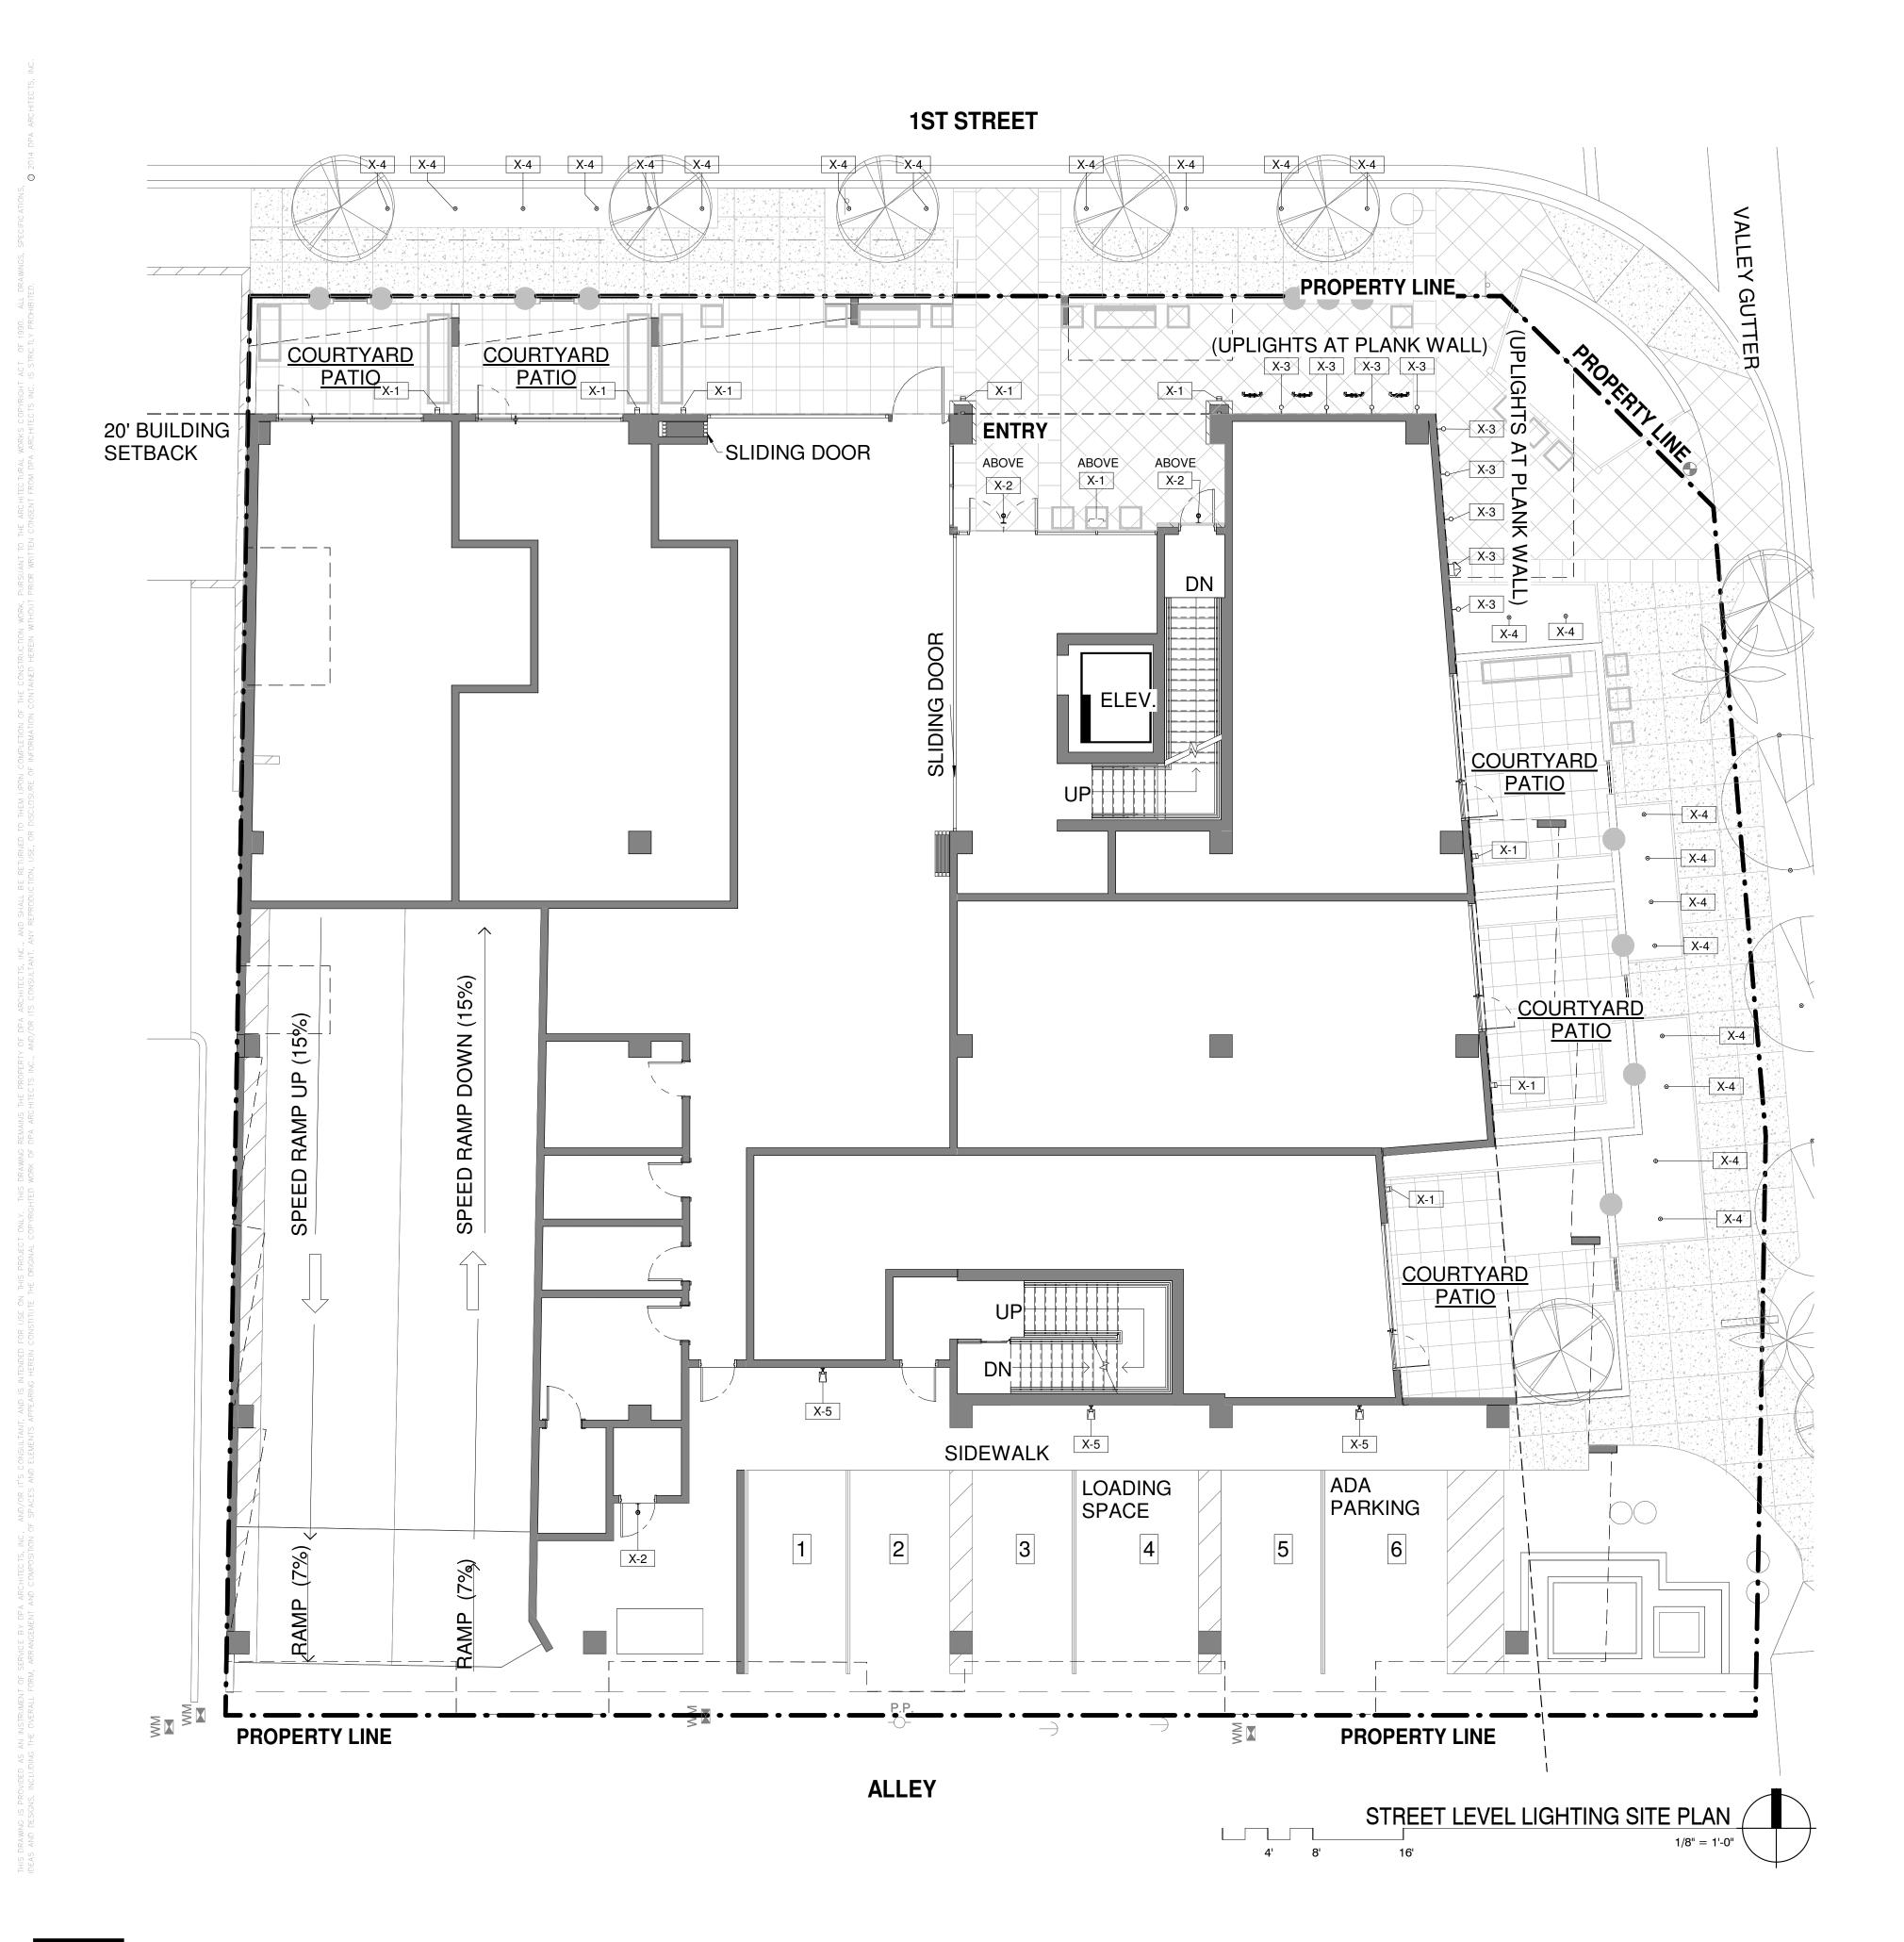

PLOT DATE: 2/16/2019 11:09:08 AM


DESIGNERS OF PROGRESSIVE ARCHITECTURE

7272 e indian school rd ste 214 scottsdale, arizona 85251 telephone 480 941 4222 www.dpaarchitects.com

REVISION INFORMATION


02/18/19

AS103 💳

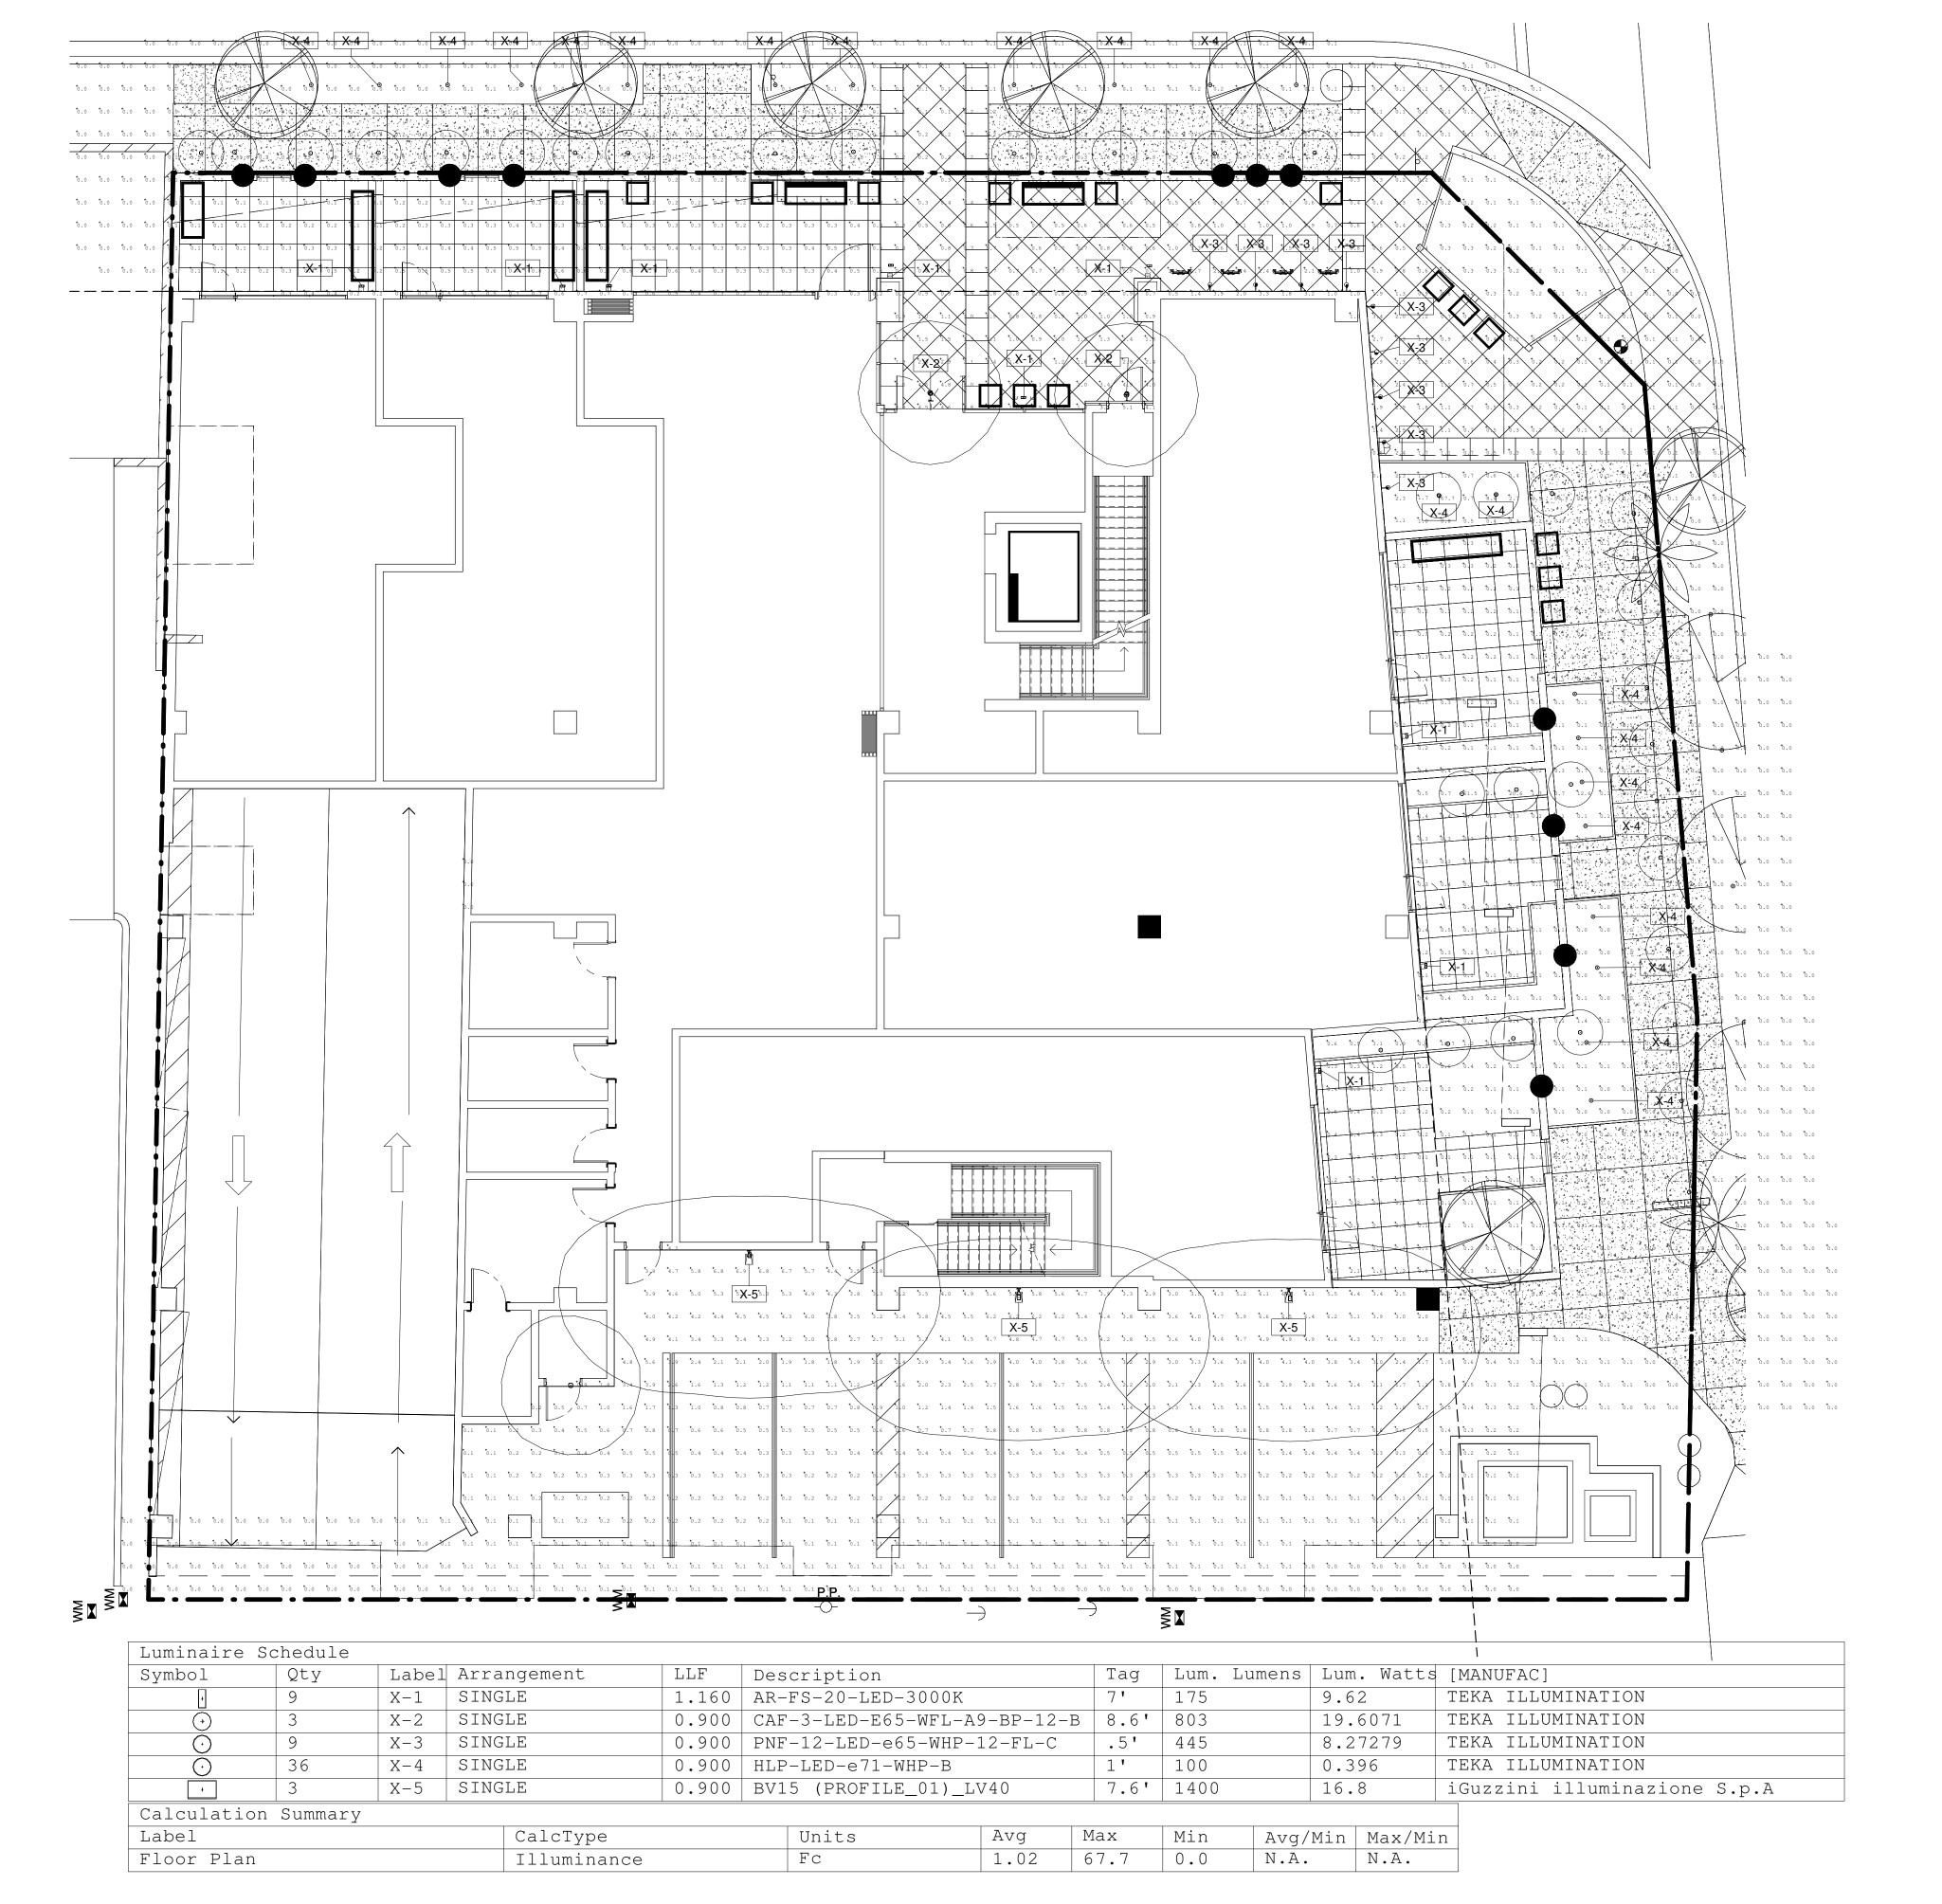


**EXTERIOR LIGHTING SITE PHOTOMETRIC - STREET LEVEL** 

CITY OF SCOTTSDALE REZONING/DR DEVELOPMENT SUBMITTAL 24-ZN-2018 AND 52-DR-2018

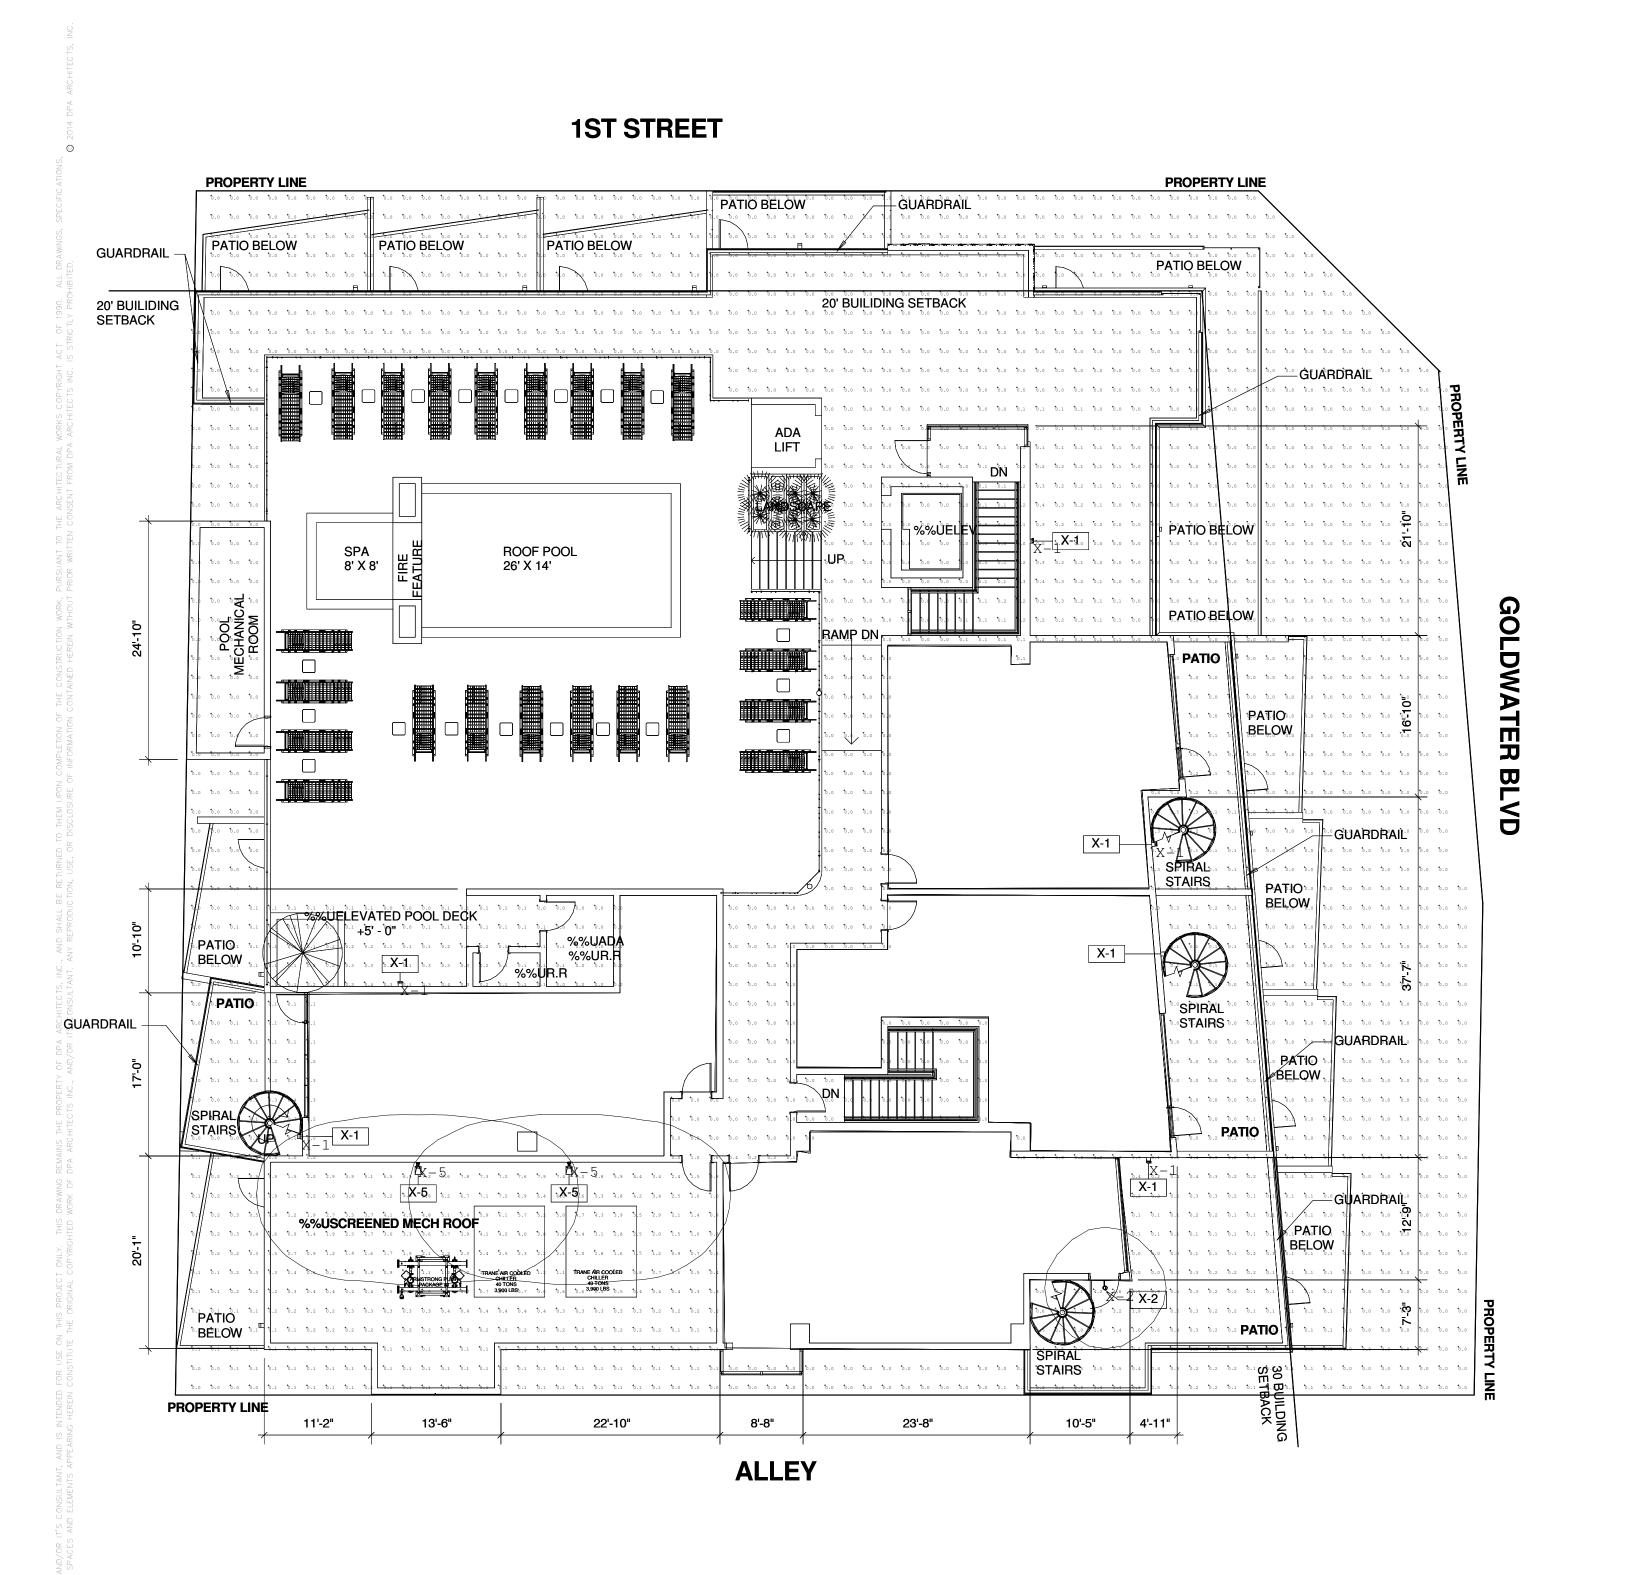

## **1ST STREET**

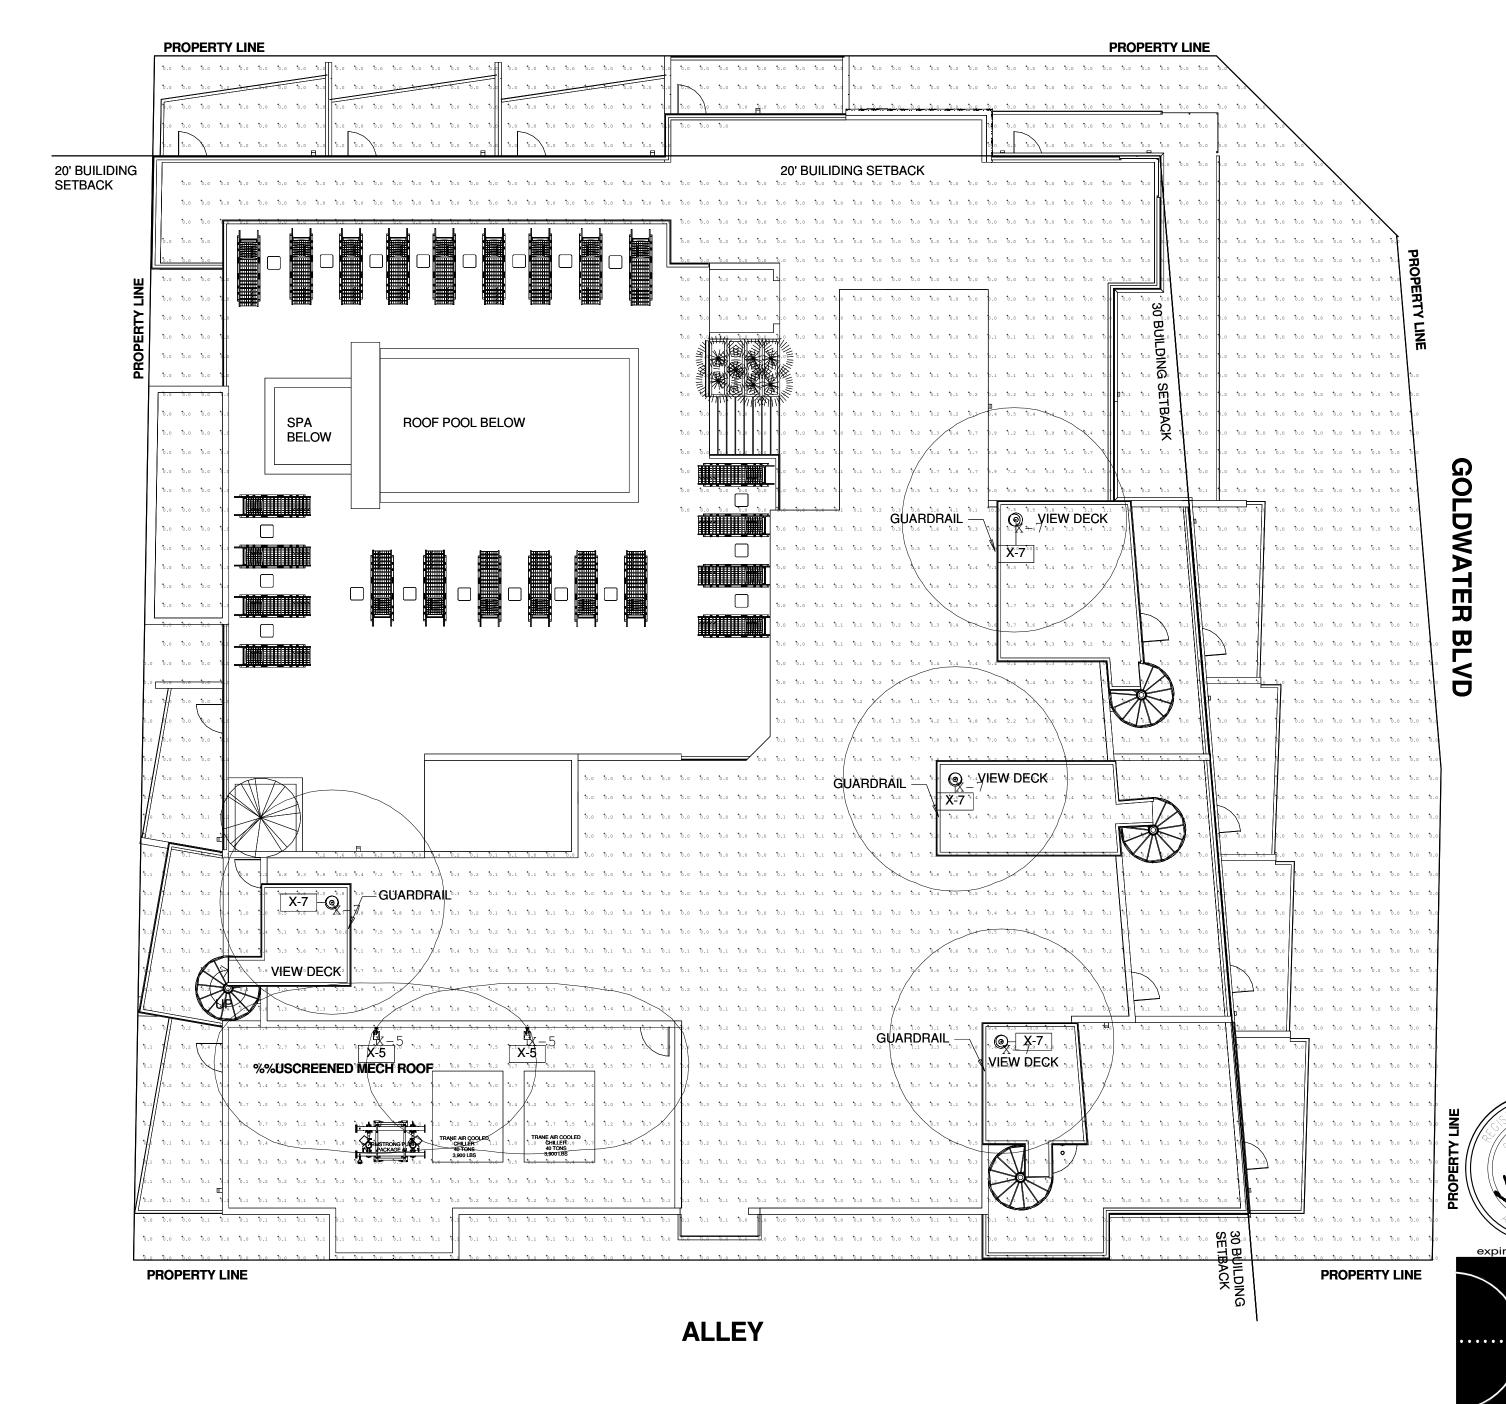

Luminaire	Schedule								
Symbol	Qty	Label	Arrangement	LLF	Description	Tag	Lum. Lumens	Lum. Watts	[MANUFAC]
,	5	X-1	SINGLE	1.060	AR-FS-20-LED-3000K	7'	175	9.62	TEKA ILLUMINATION
+	4	X-5	SINGLE	0.900	BV15 (PROFILE_01)_LV40	7.6'	1400	16.8	iGuzzini illuminazione S.p.A
<del>\$</del>	4	X-7	SINGLE	0.900	BPM-SD15-LED-x45-A	6'	1913	22.2959	TEKA ILLUMINATION
<b>(</b> +)	1	X-2	SINGLE	0.900	CAF-3-LED-E65-WFL-A9-BP-12	8.6'	803	19.6071	TEKA ILLUMINATION


Calculation Summary							
Label	CalcType	Units	Avg	Max	Min	Avg/Min	Max/Min
CalcPts_1	Illuminance	Fc	0.23	7.9	0.0	N.A.	N.A.
CalcPts_2	Illuminance	Fc	0.67	10.0	0.0	N.A.	N.A.

## **EXTERIOR LIGHTING SITE PHOTOMETRIC - ROOF LEVEL**


DESIGNERS OF PROGRESSIVE ARCHITECTURE

7272 e indian school rd ste 214 scottsdale, arizona 85251 telephone 480 941 4222 www.dpaarchitects.com


REVISION INFORMATION

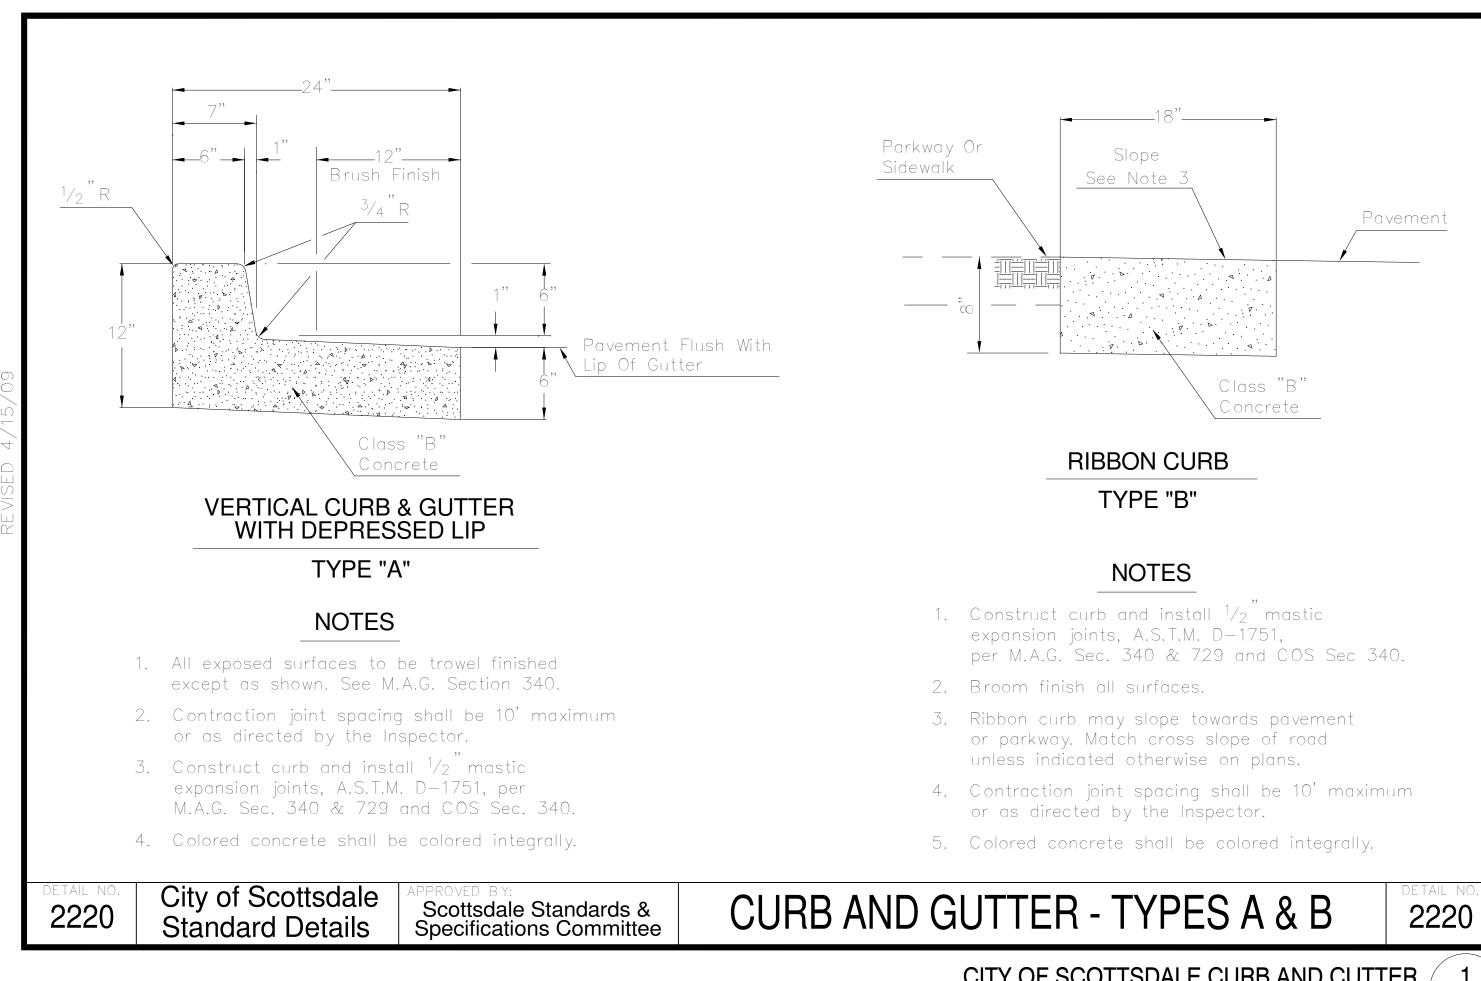

## CITY OF SCOTTSDALE CURB AND CUTTER NOT TO SCALE \ AS500

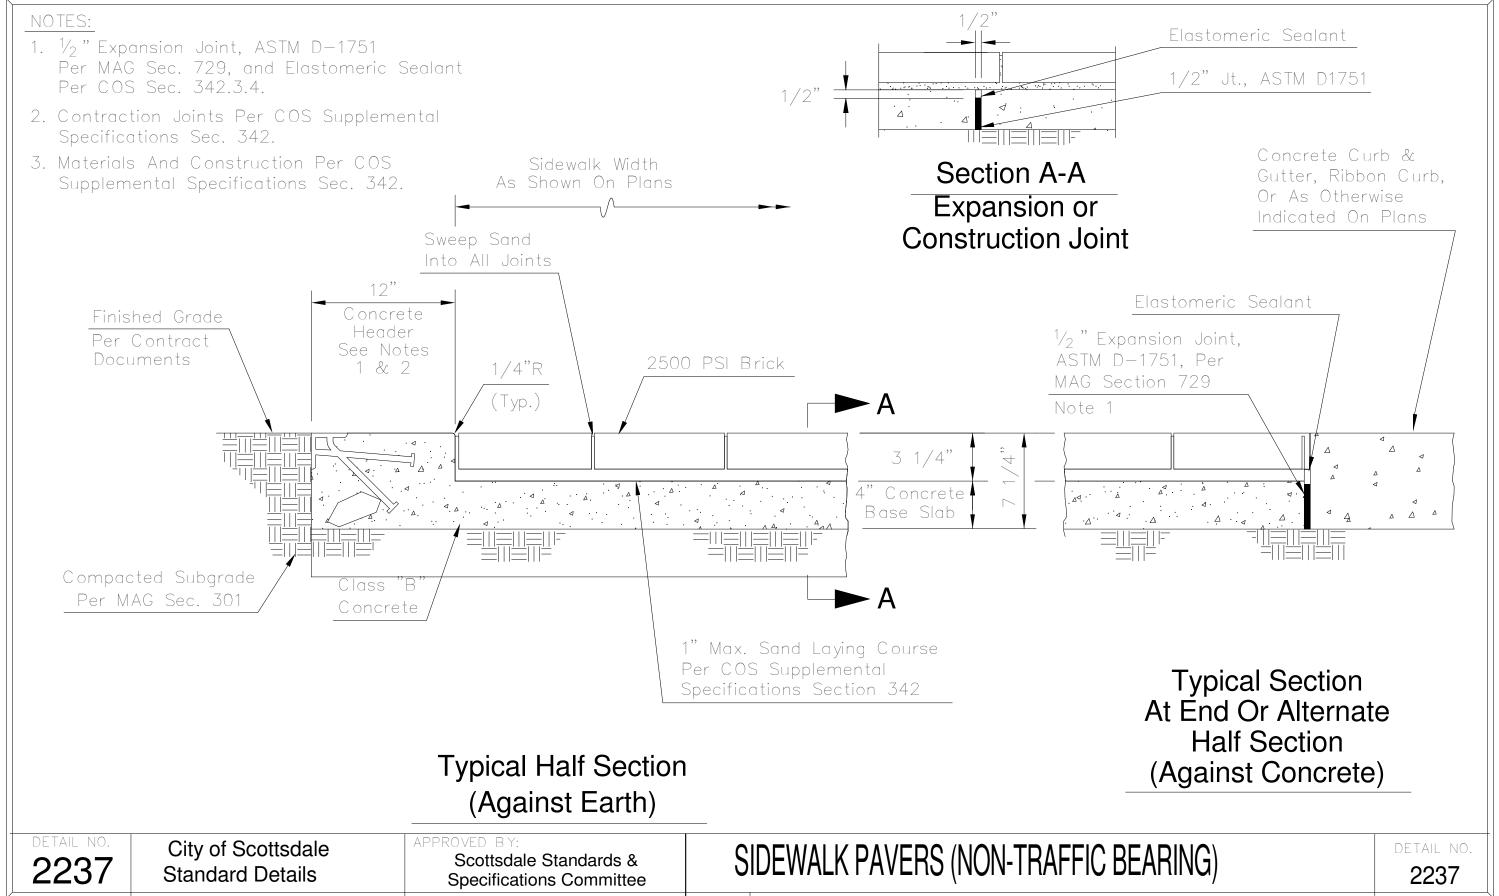

SIDEWALK PAVERS (NON-TRAFFIC BEARING) NOT TO SCALE \ AS500

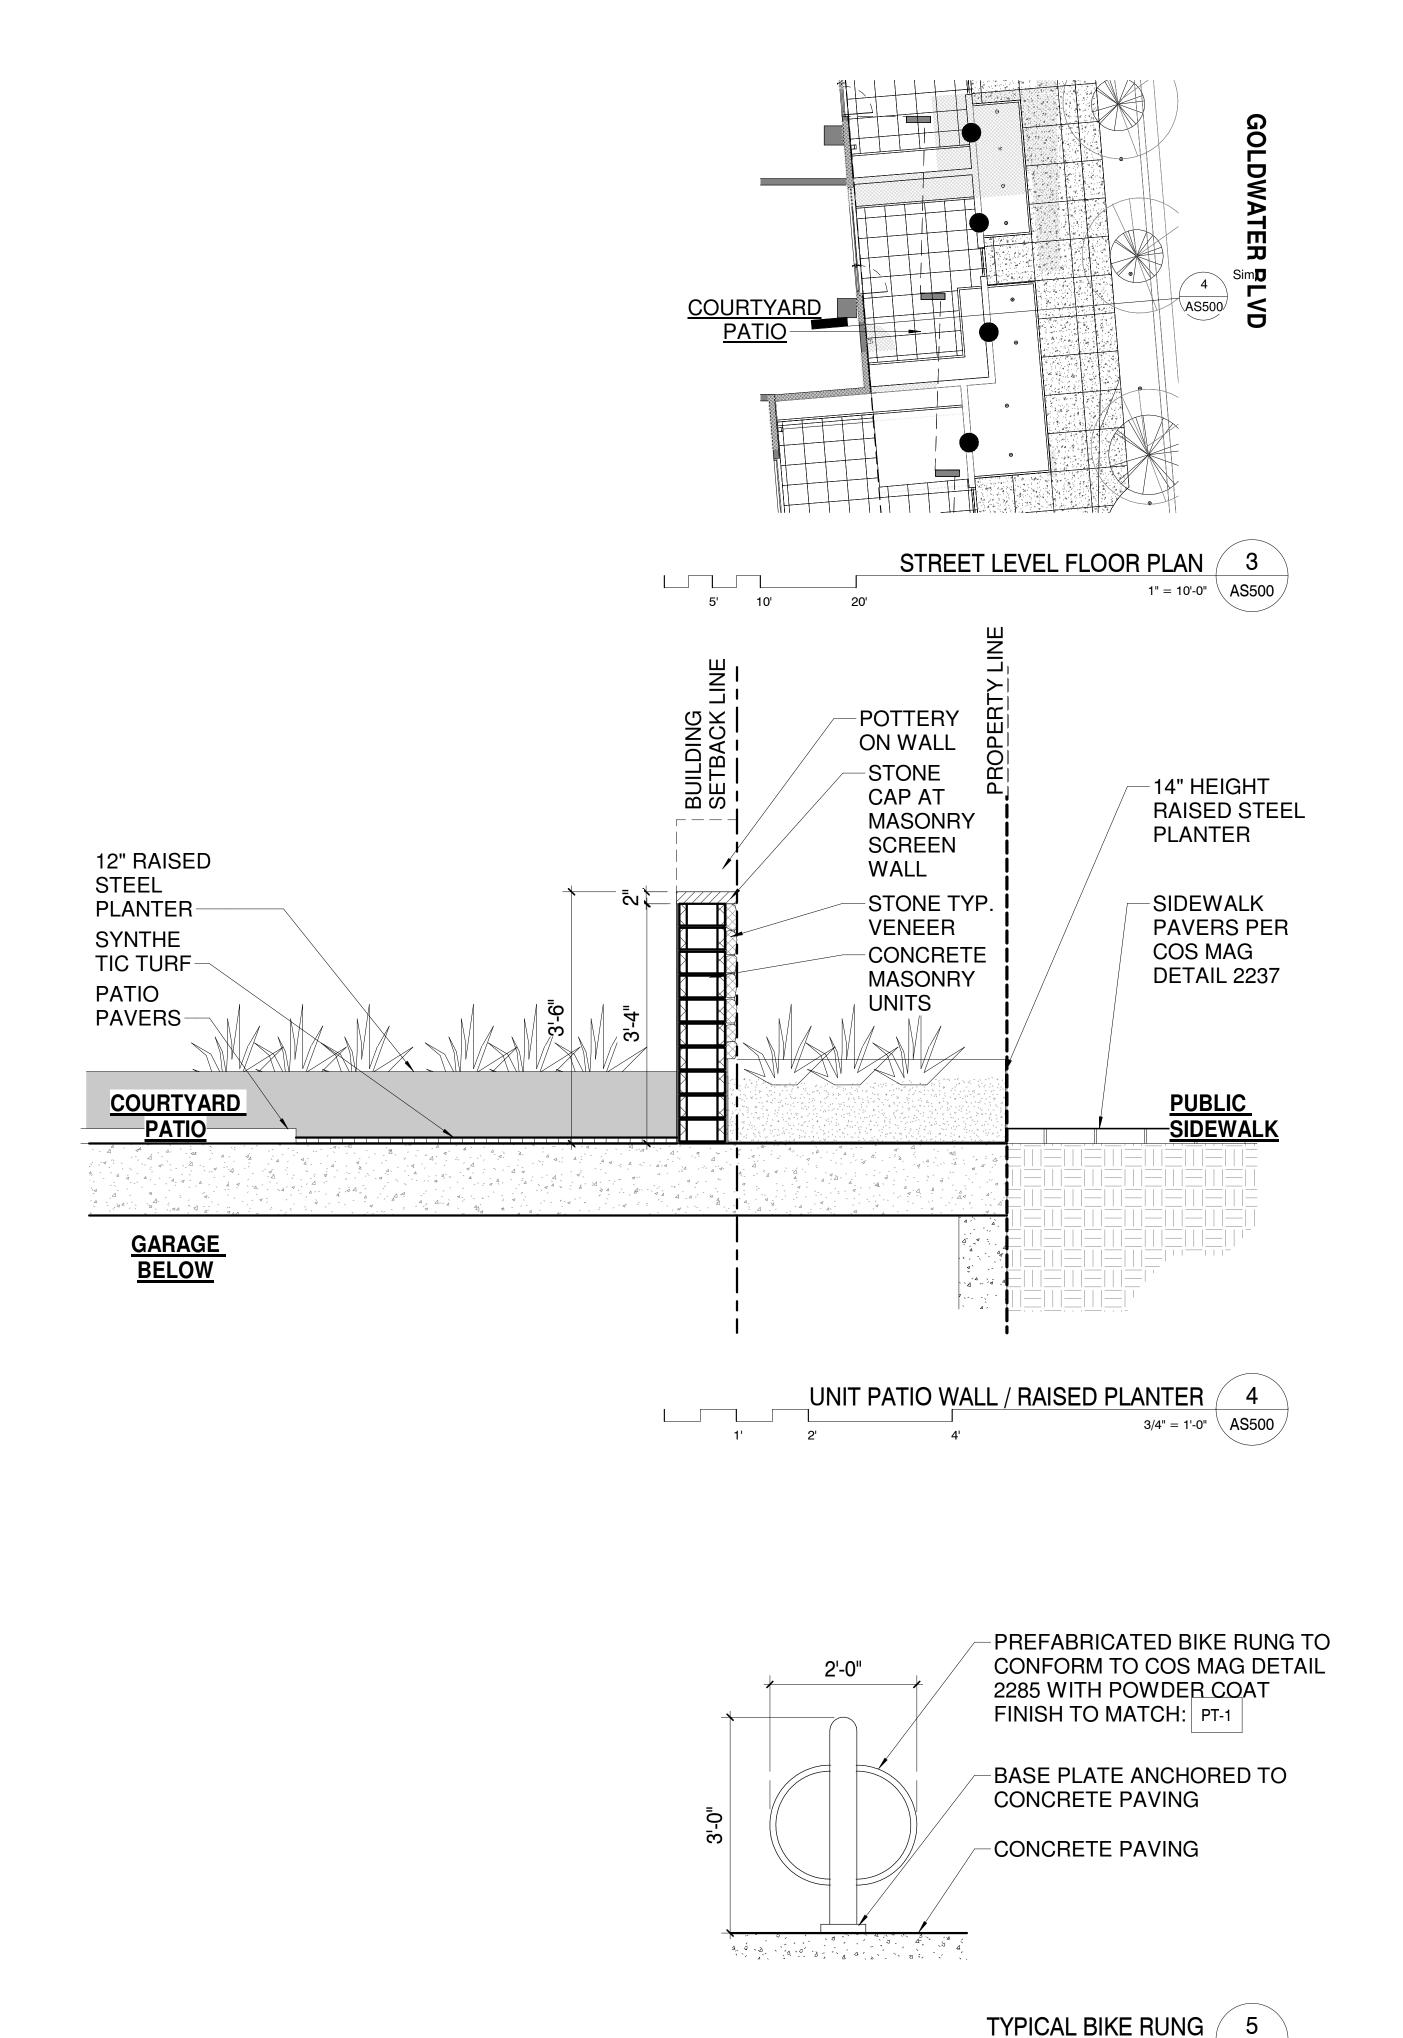

3/4" = 1'-0" \AS500

SITE DETAILS

**ESIDENCES OF SCOTTSDALE** 

WINERY R

02/18/2019

DESIGNERS OF PROGRESSIVE ARCHITECTURE

7272 e indian school rd ste 214 scottsdale, arizona 85251

telephone 480 941 4222 www.dpaarchitects.com

REVISION INFORMATION


02/18/19

AS500 -

#: Description: Date:

drawn by:

SCOTTSDALE

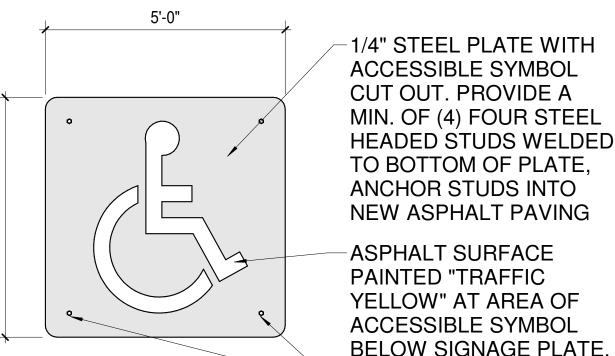

WITH ADAAG 2010.

ASPHALT SURFACE PAINTED "TRAFFIC YELLOW" AT AREA OF ACCESSIBLE SYMBOL BELOW SIGNAGE PLATE.

-HEADED STUDS AT NOTE: UNIVERSAL SYMBOL OF BOTTOM OF PLATE, TYP. ACCESSIBILITY SHALL COMPLY

ACCESSIBLE SPACES MUST BE PROMINENTLY OUTLINE IN COLORS OR MATERIALS **CONTRASTING FROM** REGULAR PARKING SPACES.


4" OUTLINE STRIPING REQUIRED, "TRAFFIC

MAXIMUM SLOP OF PARKING AND MANEUVERING AREA IS 1:50.

"YELLOW".

ACCESSIBLE PARKING SPACE SIGNAGE

NOT TO SCALE \ AS501

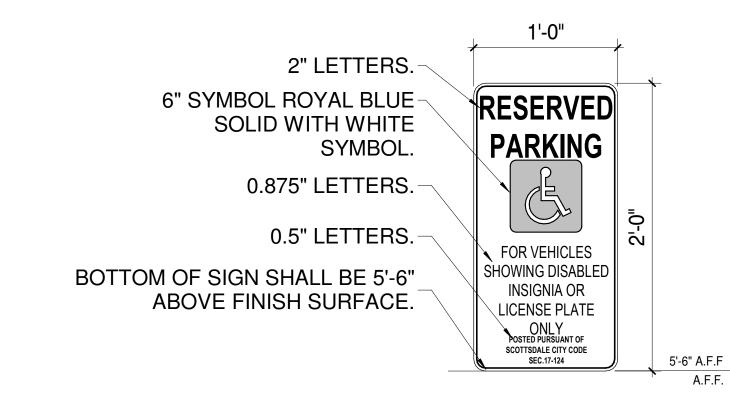

2" X 2" CUSTOM "H" SHAPE

POWDER COATED FINISH

1" X 1" TUBE STEEL SIGN

CITY OF SCOTTSDALE

STANDARD ACCESSIBLE

ANCHORED TO CONCRETE

CONCRETE FOOTING-

FINISHED GRADE

SUPPORTS WITH POWDER

STEEL FRAME WITH

COATED FINISH

THIS SHEET-

FOOTING-

**ACCESSIBLE SIGNAGE GENERAL NOTES:** 

LETTERING SHALL BE 'CLEARVIEW 1-W' FONT.


PROVIDE ONE SIGN AT EACH ACCESSIBLE PARKING STALL TO THE REAR OF THE PARKING SPACE.

SIGN POST, SLEEVE AND ANCHOR SHALL BE AS PER CITY OF SCOTTSDALE SPECIFICATION SECTION 402.3.

ALL ACCESSIBLE SPACES SHALL BE DESIGNATED BY THE INTERNATIONAL ACCESS SYMBOL

SIGNS SHALL BE PLACED A MINIMUM OF 5'-6" ABOVE PARKING SURFACE LEVEL

ACCESSIBLE PARKING SIGNAGE NOT TO SCALE \ AS501

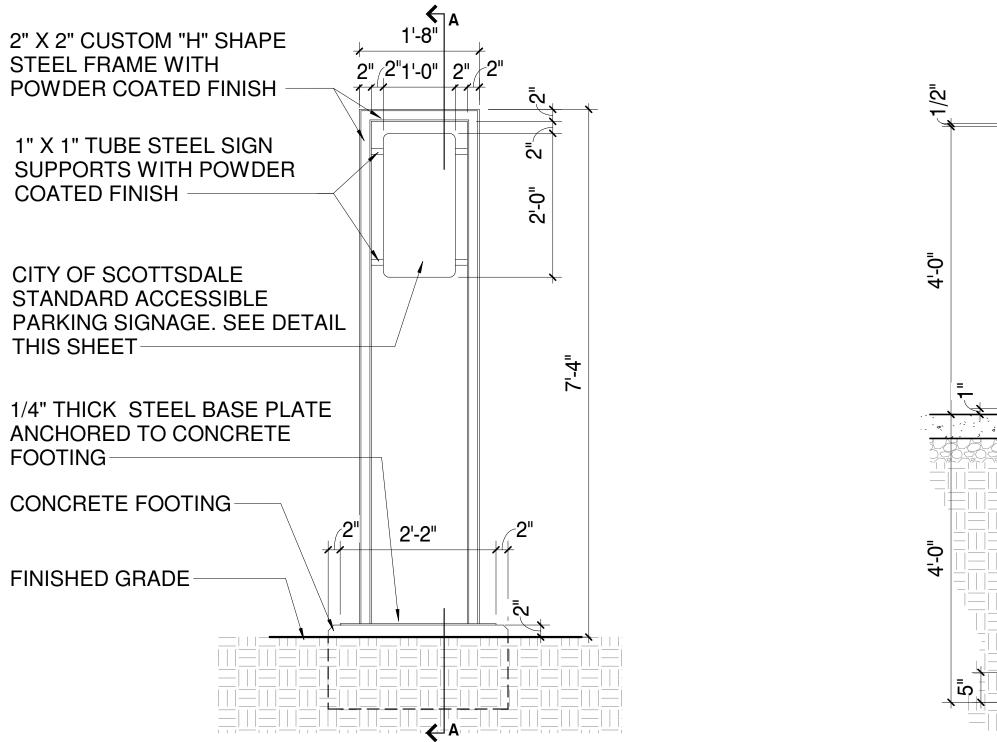

**FRONT VIEW** 

3/4" = 1'-0"  $\setminus$  AS501

ACCESSIBLE PARKING SIGN SUPPOR / 4

-ROUNDED CONCRETE CAP. -4" DIAMETER SCHEDULE 80 STEEL PIPE WITH 1/4" CLOSURE PLATE WELDED AT BOTTOM AND FILLED WITH CONCRETE. PRIME AND PAINT YELLOW. -SLOPED CONCRETE TOP WITH SMOOTH FINISH. -2'-0" DIAMETER CONCRETE FOOTING. -NEW ASPHALT PAVING. EXTENT OF STEEL PIPE WITHIN FOOTING.

> SITE BOLLARD  $3/4" = 1'-0" \setminus AS501$

SITE DETAILS

CITY OF SCOTTSDALE REZONING/DR DEVELOPMENT SUBMITTAL 24-ZN-2018 AND 52-DR-2018

expires 30 june 2019 DESIGNERS OF PROGRESSIVE ARCHITECTURE 7272 e indian school rd ste 214 scottsdale, arizona 85251 telephone 480 941 4222 www.dpaarchitects.com

drawn by:

02/18/19

PLOT DATE: 2/16/2019 11:23:23 AM

2" X 2" CUSTOM "H" SHAPE

POWDER COATED FINISH

1" X 1" TUBE STEEL SIGN

POWDER COATED FINISH

CITY OF SCOTTSDALE

B) SEE FINISH

CONCRETE

**ASPHALT** 

PAVING-

CURB-

SCHEDULE FOR

ADDITIONAL INFO.

STANDARD ACCESSIBLE

PARKING SIGNAGE. SEE DETAIL

A) ALL POWDER COATED

SURFACES TO BE : PT-1

2'-3"

**SECTION A-A** 

STEEL FRAME WITH

SUPPORTS WITH

THIS SHEET-

<u>NOTE</u>

**WINERY R** 

**ISDALE** 

OF

SCOTTSDALE

REVISION INFORMATION #: Description: Date:

AS501 =

20" ARCADE FULL SHIELD (FS)

**TEKA** 

ΓYPE: X-1

C AR	FS	20	LED	39	1 BP	WHT 120	
Example - AR -	FS -	20 -	LED	- 39	0 - BLP -	- HRN - 120	
Material — Blank - Aluminum C - Copper							
S - Stainless Steel Series  AR - Arcade							
Style —							
FS - Full Shield							
Wall Plate —							
<b>20</b> - 20 Inch							
Source —							
LED Type							
390 - 10WLED/2700K 391 - 10WLED/3000K 392 - 10WLED/4000K							
Finish —							
NAT - Natural* (Copper and Stainless only.)	Powder Coat S	Standard	Finish			Powder Coat Pre	mium Finish
<b>BP</b> - Brown Patina* (Copper only.)	Powder Coat Color	Satin	Wrinkle	ABP	Antique Brass Powder	CMG Cascade Mou	
GP - Green Patina* (Copper only.)	Bronze	BZP	BZW		Aleutian Mountain Gran		SDS Sonoran Desert Sandsto
NIC - Nickel Plate* (Copper only.)	Black	BLP	BLW		Antique White	CRM Cream	SMG Sierra Mountain Granite
POL - Polish* (Copper and Stainless only.)	White (Gloss) Aluminum	SAP	WHW		Black Chrome	HUG Hunter Green	
BRU - Brush* (Stainless only.) BZW - For Aluminum fixtures, specify Standard	Verde	- JAP	VER		Beige Brown Patina Powder	MDS Mojave Dese	
or Premium Powder Coat.	verde			100000 100	Clear Anodized Powder		Also available in RAL Finishe. See submittal SUB-1439-00
Diffuser —							See Suomittal 2015-14-29-00
WHT - TranslucentWhite ALB - White Alabaster ROS - Rose Alabaster HRN - Natural Horn CAR - Carmel							
RAD - Radiant Flame							

RANSFORMER DA	TA

**120** - 120 VAC **277** - 277 VAC

ART - Laser Engraved Faceplate Art

CLR - Clear Coat Protection (For use with Natural (NAT) and Polished (POL) finishes only. *Not available with Aluminum.)

AC Input Range	Output Range	Frequency Hz	Power Factor At Full Loa (Efficiency)	ad THD	Operation Ambient Temperature
120V	12V	50/60 Hz	>.98	<13%	-10°F to 130° F (-23° C to 54° C)
277V	12V	50/60 Hz	>.97	<13%	-10°F to 130° F (-23° C to 54° C)
M79 DATA				1	L70 DATA
TEKA LED#	LUMENS (Delivered)	сст	INPUT WATTS (Typ.)	CRI (Typ.)	Minimum Rated Life (hrs.) - 70% of initial lumens (L70)
390	152	2700	10	90	50,000
391	203	3000	10	80	50,000




**CARDINAL FLOODLIGHT (CAF)** 

TYPE: X-2

C   CAF	3 <b>LED</b>	E65 W	/FL A9 BP	12 B	360SL
Example - CAF -	6" - LED		SP - A9 - BCM -	12 - 11 - A	- 360SL -
Material —	1 1	1		ī ï ï	
Blank - Aluminum C - Copper					
Series					
CAF - Cardinal Floodlight					
-					
Stem Length —	_				
- 3", 6", 12", 18", 24", 30"					
Source —					
LED - 'e'Technology with Integral Dimn	ming Driver (See Specific	cations for Dimming)			
Designed for use with remote 12VAC BKS	SSL [®] transformers. Require:	s magnetic Low Voltage Di	nmer.		
LED Type ————					
e64 - 8WLED/2700K	<b>e66</b> - 8WL	FD/4000K			
e65 - 8WLED/3000K	e74 - 8WL				
Optics —	5409 Section (54088604)	section ( ** not compare to be compare)			
The second secon	MFL - Med	:			
NSP - Narrow Spot SP - Spot	WFL - Med				
Adjust-e-Lume® Output Intensity «	Choose factory Setting) -				
					1 1
A9 (Standard), A8, A7, A6, A5, A4, A3	, A2, A1				
	, A2, A1				
Finish —		Standard Finish		Powder Coat Premium Finis	
		Standard Finish Satin Wrinkle	ABP Antique Brass Powder	Powder Coat Premium Finisl CMG Cascade Mountain Granite	
Finish NAT - Natural*	Powder Coat !		ABP Antique Brass Powder AMG Aleutian Mountain Granite		RMG Rocky Mountain Gr
Finish  NAT - Natural*  BP - Brown Patina*	Powder Coat S	Satin Wrinkle		CMG Cascade Mountain Granite	RMG Rocky Mountain Gr SDS Sonoran Desert Sar
Finish  NAT - Natural* BP - Brown Patina* GP - Green Patina* NIC - Nickel Plate* BZW - Bronze Wrinkle	Powder Coat S Powder Coat Color Bronze	Satin Wrinkle BZP BZW	AMG Aleutian Mountain Granite	CMG Cascade Mountain Granite CRI Cracked Ice	
Finish  NAT - Natural* BP - Brown Patina* GP - Green Patina* NIC - Nickel Plate* BZW - Bronze Wrinkle See Powder Coat Finish Chart to the right for additional choices.	Powder Coat :  Powder Coat Color  Bronze  Black  White (Gloss)  Aluminum	Satin Wrinkle BZP BZW BLP BLW WHP WHW SAP —	AMG Aleutian Mountain Granite AQW Antique White BCM Black Chrome BGE Beige	CMG Cascade Mountain Granite CRI Cracked Ice CRM Cream HUG Hunter Green MDS Mojave Desert Sandstone	RMG Rocky Mountain Gr SDS Sonoran Desert Sar SMG Sierra Mountain Gr TXF Textured Forest WCP Weathered Copper
Finish  NAT - Natural*  BP - Brown Patina*  GP - Green Patina*  NIC - Nickel Plate*  BZW - Bronze Wrinkle  See Powder Coat Finish Chart to the right for additional choices. *Not available with Aluminum. For	Powder Coat Solor Bronze Black White (Gloss)	Satin Wrinkle BZP BZW BLP BLW WHP WHW	AMG Aleutian Mountain Granite AQW Antique White BCM Black Chrome BGE Beige BPP Brown Patina Powder	CMG Cascade Mountain Granite CRI Cracked Ice CRM Cream HUG Hunter Green MDS Mojave Desert Sandstone NBP Natural Brass Powder	RMG Rocky Mountain Gr SDS Sonoran Desert Sar SMG Sierra Mountain Gr TXF Textured Forest WCP Weathered Copper WIR Weathered Iron
Finish  NAT - Natural* BP - Brown Patina* GP - Green Patina* NIC - Nickel Plate* BZW - Bronze Wrinkle See Powder Coat Finish Chart to the right for additional choices.	Powder Coat :  Powder Coat Color  Bronze  Black  White (Gloss)  Aluminum	Satin Wrinkle BZP BZW BLP BLW WHP WHW SAP —	AMG Aleutian Mountain Granite AQW Antique White BCM Black Chrome BGE Beige	CMG Cascade Mountain Granite CRI Cracked Ice CRM Cream HUG Hunter Green MDS Mojave Desert Sandstone	RMG Rocky Mountain Gr SDS Sonoran Desert Sar SMG Sierra Mountain Gr TXF Textured Forest WCP Weathered Copper WIR Weathered Iron Also available in RAL Fi
Finish  NAT - Natural*  BP - Brown Patina*  GP - Green Patina*  NIC - Nickel Plate*  BZW - Bronze Wrinkle  See Powder Coat Finish Chart  to the right for additional choices.  "Not available with Aluminum. For  Aluminum fixtures, specify Standard or  Premium Powder Coat.	Powder Coat :  Powder Coat Color  Bronze  Black  White (Gloss)  Aluminum	Satin Wrinkle BZP BZW BLP BLW WHP WHW SAP —	AMG Aleutian Mountain Granite AQW Antique White BCM Black Chrome BGE Beige BPP Brown Patina Powder	CMG Cascade Mountain Granite CRI Cracked Ice CRM Cream HUG Hunter Green MDS Mojave Desert Sandstone NBP Natural Brass Powder	RMG Rocky Mountain Gr SDS Sonoran Desert Sar SMG Sierra Mountain Gr TXF Textured Forest WCP Weathered Copper WIR Weathered Iron Also available in RAL Fi
Finish  NAT - Natural*  BP - Brown Patina*  GP - Green Patina*  NIC - Nickel Plate*  BZW - Bronze Wrinkle  See Powder Coat Finish Chart to the right for additional choices.  Not available with Aluminum. For Aluminum fixtures, specify Standard or Premium Powder Coat.  Lens Type	Powder Coat :  Powder Coat Color  Bronze  Black  White (Gloss)  Aluminum  Verde	Satin Wrinkle BZP BZW BLP BLW WHP WHW SAP —	AMG Aleutian Mountain Granite AQW Antique White BCM Black Chrome BGE Beige BPP Brown Patina Powder	CMG Cascade Mountain Granite CRI Cracked Ice CRM Cream HUG Hunter Green MDS Mojave Desert Sandstone NBP Natural Brass Powder	RMG Rocky Mountain Gr SDS Sonoran Desert Sar SMG Sierra Mountain Gr TXF Textured Forest WCP Weathered Copper WIR Weathered Iron Also available in RAL Fi
Finish  NAT - Natural*  BP - Brown Patina*  GP - Green Patina*  NIC - Nickel Plate*  BZW - Bronze Wrinkle  See Powder Coat Finish Chart to the right for additional choices *Not available with Aluminum. For Aluminum fixtures, specify Standard or Premium Powder Coat.  Lens Type  12 - Soft Focus Lens  13 - Re	Powder Coat :  Powder Coat Color  Bronze  Black  White (Gloss)  Aluminum  Verde	Satin Wrinkle BZP BZW BLP BLW WHP WHW SAP — VER	AMG Aleutian Mountain Granite AQW Antique White BCM Black Chrome BGE Beige BPP Brown Patina Powder CAP Clear Anodized Powder	CMG Cascade Mountain Granite CRI Cracked Ice CRM Cream HUG Hunter Green MDS Mojave Desert Sandstone NBP Natural Brass Powder	RMG Rocky Mountain Gr SDS Sonoran Desert Sar SMG Sierra Mountain Gr TXF Textured Forest WCP Weathered Copper WIR Weathered Iron Also available in RAL Fi
Finish  NAT - Natural* BP - Brown Patina* GP - Green Patina* NIC - Nickel Plate* BZW - Bronze Wrinkle See Powder Coat Finish Chart to the right for additional choices. *Not available with Aluminum. For Aluminum fixtures, specify Standard or Premium Powder Coat.  Lens Type  12 - Soft Focus Lens  13 - Re	Powder Coat :  Powder Coat Color  Bronze  Black  White (Gloss)  Aluminum  Verde	Satin Wrinkle BZP BZW BLP BLW WHP WHW SAP —	AMG Aleutian Mountain Granite AQW Antique White BCM Black Chrome BGE Beige BPP Brown Patina Powder CAP Clear Anodized Powder	CMG Cascade Mountain Granite CRI Cracked Ice CRM Cream HUG Hunter Green MDS Mojave Desert Sandstone NBP Natural Brass Powder	RMG Rocky Mountain G SDS Sonoran Desert Sa SMG Sierra Mountain Gi TXF Textured Forest WCP Weathered Coppe WIR Weathered Iron Also available in RALF
Finish  NAT - Natural*  BP - Brown Patina*  GP - Green Patina*  NIC - Nickel Plate*  BZW - Bronze Wrinkle  See Powder Coat Finish Chart  to the right for additional choices  "Not available with Aluminum. For  Aluminum fixtures, specify Standard or  Premium Powder Coat.  Lens Type  12 - Soft Focus Lens  13 - Re	Powder Coat :  Powder Coat Color  Bronze  Black  White (Gloss)  Aluminum  Verde	Satin Wrinkle BZP BZW BLP BLW WHP WHW SAP — VER	AMG Aleutian Mountain Granite AQW Antique White BCM Black Chrome BGE Beige BPP Brown Patina Powder CAP Clear Anodized Powder	CMG Cascade Mountain Granite CRI Cracked Ice CRM Cream HUG Hunter Green MDS Mojave Desert Sandstone NBP Natural Brass Powder	RMG Rocky Mountain Gr SDS Sonoran Desert Sar SMG Sierra Mountain Gr TXF Textured Forest WCP Weathered Copper WIR Weathered Iron Also available in RAL Fi
Finish  NAT - Natural* BP - Brown Patina* GP - Green Patina* NIC - Nickel Plate* BZW - Bronze Wrinkle See Powder Coat Finish Chart to the right for additional choices *Not available with Aluminum. For Aluminum fixtures, specify Standard or Premium Powder Coat.  Lens Type  12 - Soft Focus Lens 13 - Re  Shielding 11 - Honeycomb Baffle	Powder Coat :  Powder Coat Color  Bronze  Black  White (Gloss)  Aluminum  Verde	Satin Wrinkle BZP BZW BLP BLW WHP WHW SAP — VER	AMG Aleutian Mountain Granite AQW Antique White BCM Black Chrome BGE Beige BPP Brown Patina Powder CAP Clear Anodized Powder	CMG Cascade Mountain Granite CRI Cracked Ice CRM Cream HUG Hunter Green MDS Mojave Desert Sandstone NBP Natural Brass Powder	RMG Rocky Mountain Gr SDS Sonoran Desert Sar SMG Sierra Mountain Gr TXF Textured Forest WCP Weathered Copper WIR Weathered Iron Also available in RAL Fi
Finish  NAT - Natural* BP - Brown Patina* GP - Green Patina* NIC - Nickel Plate* BZW - Bronze Wrinkle See Powder Coat Finish Chart to the right for additional choices *Not available with Aluminum. For Aluminum fixtures, specify Standard or Premium Powder Coat.  Lens Type  12 - Soft Focus Lens 13 - Re  Shielding 11 - Honeycomb Baffle	Powder Coat :  Powder Coat Color  Bronze  Black  White (Gloss)  Aluminum  Verde	Satin Wrinkle BZP BZW BLP BLW WHP WHW SAP — VER	AMG Aleutian Mountain Granite AQW Antique White BCM Black Chrome BGE Beige BPP Brown Patina Powder CAP Clear Anodized Powder	CMG Cascade Mountain Granite CRI Cracked Ice CRM Cream HUG Hunter Green MDS Mojave Desert Sandstone NBP Natural Brass Powder OCP Old Copper	RMG Rocky Mountain Gr SDS Sonoran Desert Sar SMG Sierra Mountain Gr TXF Textured Forest WCP Weathered Copper WIR Weathered Iron Also available in RAL Fr See submittal SUB-14:
Finish  NAT - Natural* BP - Brown Patina* GP - Green Patina* NIC - Nickel Plate* BZW - Bronze Wrinkle See Powder Coat Finish Chart to the right for additional choices. *Not available with Aluminum. For Aluminum fixtures, specify Standard or Premium Powder Coat.  Lens Type  12 - Soft Focus Lens 13 - Ro  Shielding 11 - Honeycomb Baffle  Cap Style (Material and Finish to match Fixture.)  A - 45° B - 90°	Powder Coat :  Powder Coat Color  Bronze  Black  White (Gloss)  Aluminum  Verde  C - Flush	Satin Wrinkle BZP BZW BLP BLW WHP WHW SAP — VER	AMG Aleutian Mountain Granite AQW Antique White BCM Black Chrome BGE Beige BPP Brown Patina Powder CAP Clear Anodized Powder	CMG Cascade Mountain Granite CRI Cracked Ice CRM Cream HUG Hunter Green MDS Mojave Desert Sandstone NBP Natural Brass Powder	RMG Rocky Mountain Gr SDS Sonoran Desert Sar SMG Sierra Mountain Gr TXF Textured Forest WCP Weathered Copper WIR Weathered Iron Also available in RAL Fi See submittal SUB-143
Finish  NAT - Natural* BP - Brown Patina* GP - Green Patina* NIC - Nickel Plate* BZW - Bronze Wrinkle See Powder Coat Finish Chart to the right for additional choices. *Not available with Aluminum. For Aluminum Ristures, specify Standard or Premium Powder Coat.  Lens Type  12 - Soft Focus Lens 13 - Re  Shielding  11 - Honeycomb Baffle  Cap Style (Material and Finish to match Fixture.)  A - 45° B - 90°  Knuckle Style (Material and Finish to match Fixture.)	Powder Coat :  Powder Coat Color Bronze Black White (Gloss) Aluminum Verde  C - Flush	Satin Wrinkle BZP BZW BLP BLW WHP WHW SAP — VER	AMG Aleutian Mountain Granite AQW Antique White BCM Black Chrome BGE Beige BPP Brown Patina Powder CAP Clear Anodized Powder	CMG Cascade Mountain Granite CRI Cracked Ice CRM Cream HUG Hunter Green MDS Mojave Desert Sandstone NBP Natural Brass Powder OCP Old Copper	RMG Rocky Mountain Gr SDS Sonoran Desert Sar SMG Sierra Mountain Gr TXF Textured Forest WCP Weathered Copper WIR Weathered Iron Also available in RAL Fi See submittal SUB-143
Finish  NAT - Natural* BP - Brown Patina* GP - Green Patina* NIC - Nickel Plate* BZW - Bronze Wrinkle See Powder Coat Finish Chart to the right for additional choices. *Not available with Aluminum. For Aluminum Ristures, specify Standard or Premium Powder Coat.  Lens Type  12 - Soft Focus Lens 13 - Ro  Shielding 11 - Honeycomb Baffle  Cap Style (Material and Finish to match Fixture)	Powder Coat :  Powder Coat Color  Bronze  Black  White (Gloss)  Aluminum  Verde  C - Flush  re.)	Satin Wrinkle BZP BZW BLP BLW WHP WHW SAP — VER	AMG Aleutian Mountain Granite AQW Antique White BCM Black Chrome BGE Beige BPP Brown Patina Powder CAP Clear Anodized Powder	CMG Cascade Mountain Granite CRI Cracked Ice CRM Cream HUG Hunter Green MDS Mojave Desert Sandstone NBP Natural Brass Powder OCP Old Copper	RMG Rocky Mountain Gr SDS Sonoran Desert Sar SMG Sierra Mountain Gr TXF Textured Forest WCP Weathered Copper WIR Weathered Iron Also available in RAL Fi See submittal SUB-143



PINNACLE FLOODLIGHT (PNF)

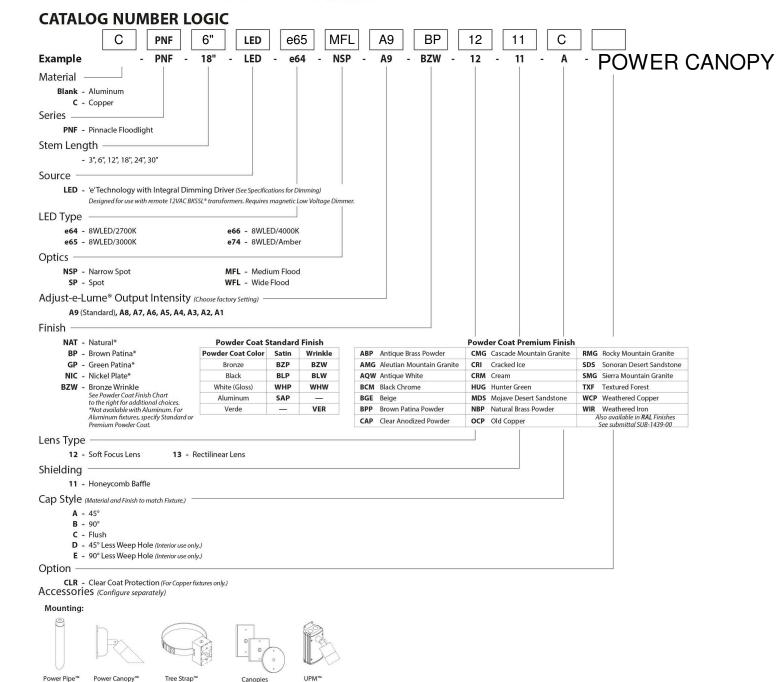



**CLASSIC HIGH LIGHT PATH (HLP-C) TEKA** 

TYPE: X-4

	C HLP	12	c	LED	e71 BP			
Example	- HLP	- 12 -	c .	LED	- e70 - BZP		- #50	
• Material =		Ī	Ĩ			Ì		
	- Aluminum							
	- Aluminum - Copper							
Series —	100							
	- High Light Path							
	gth (Specify Inches)							
-	- 12", 18", 24", 30", 36", 42"							
Style —			_					
	- Classic							
Source —								
	- 'e' Technology with Integral Driv	er						
LED -	NA THE STATE OF TH							
LED -	*For use with Remote BKSSL® Transform							
LED Type	*For use with Remote BKSSL® Transform							
LED Type	*For use with Remote BKSSL® Transform							
LED Type	*For use with Remote BKSSL* Transform  - 3WLED/2700K <b>e72</b> - 3V	er - non-dimmable.						
LED Type	*For use with Remote BKSSL* Transform  - 3WLED/2700K <b>e72</b> - 3V	vLED/4000K						
LED Type e70 - e71 - Finish —	*For use with Remote BKSSL* Transform  - 3WLED/2700K <b>e72</b> - 3V	vLED/4000K	Standard	1 Finish		Powde	r Coat Premium Finish	1
LED Type e70 - e71 - Finish — NAT -	*For use with Remote BKSSL* Transform  - 3WLED/2700K	vLED/4000K VLED/Amber		l Finish Wrinkle	ABP Antique Brass Powd		<b>r Coat Premium Finish</b> Cascade Mountain Granite	1 RMG Rocky Mountain Granite
LED Type e70 - e71 - Finish — NAT - BP - GP -	*For use with Remote BKSSL* Transform  - 3WLED/2700K	VLED/4000K VLED/Amber  Powder Coat :  Powder Coat Color  Bronze	Satin BZP		ABP Antique Brass Powd- AMG Aleutian Mountain G	ler CMG C	Cascade Mountain Granite Cracked Ice	RMG Rocky Mountain Granite
LED Type e70 - e71 - Finish — NAT - BP - GP - NIC -	*For use with Remote BKSSL* Transform  - 3WLED/2700K	VLED/4000K VLED/Amber  Powder Coat :  Powder Coat Color  Bronze  Black	Satin BZP BLP	Wrinkle BZW BLW	AMG Aleutian Mountain G AQW Antique White	ler CMG C Granite CRI C CRM C	Cascade Mountain Granite Cracked Ice Cream	RMG Rocky Mountain Granite SDS Sonoran Desert Sandstor SMG Sierra Mountain Granite
LED Type e70 - e71 - Finish — NAT - BP - GP - NIC -	*For use with Remote BKSSL* Transform  - 3WLED/2700K	Powder Coat S Powder Coat Color Bronze Black White (Gloss)	Satin BZP BLP WHP	Wrinkle BZW BLW WHW	AMG Aleutian Mountain G AQW Antique White BCM Black Chrome	Granite CRI CRM	Cascade Mountain Granite Cracked Ice Cream Hunter Green	RMG Rocky Mountain Granite SDS Sonoran Desert Sandstor SMG Sierra Mountain Granite TXF Textured Forest
LED Type e70 - e71 - Finish — NAT - BP - GP - NIC -	*For use with Remote BKSSL* Transform  - 3WLED/2700K	Powder Coat :  Powder Coat :  Powder Coat Since  Bronze  Black  White (Gloss)  Aluminum	Satin BZP BLP WHP SAP	Wrinkle BZW BLW WHW	AMG Aleutian Mountain G AQW Antique White BCM Black Chrome BGE Beige	ler CMG C Granite CRI C CRM C HUG H MDS M	Cascade Mountain Granite Cracked Ice Cream Hunter Green Mojave Desert Sandstone	RMG Rocky Mountain Granite SDS Sonoran Desert Sandstor SMG Sierra Mountain Granite TXF Textured Forest WCP Weathered Copper
LED Type e70 - e71 - Finish — NAT - BP - GP - NIC -	*For use with Remote BKSSL* Transform  3WLED/2700K	Powder Coat S Powder Coat Color Bronze Black White (Gloss)	Satin BZP BLP WHP	Wrinkle BZW BLW WHW	AMG Aleutian Mountain C AQW Antique White BCM Black Chrome BGE Beige BPP Brown Patina Powde	er CMG C Granite CRI C CRM C HUG H MDS M er NBP M	Cascade Mountain Granite Cracked Ice Cream Hunter Green Mojave Desert Sandstone Natural Brass Powder	RMG Rocky Mountain Granite  SDS Sonoran Desert Sandstor  SMG Sierra Mountain Granite  TXF Textured Forest  WCP Weathered Copper  WIR Weathered Iron  Also available in RAL Finishes
LED Type e70 - e71 - Finish —  NAT - BP - GP - NIC - BZW -	*For use with Remote BKSSL* Transform  3WLED/2700K	Powder Coat :  Powder Coat :  Powder Coat Since  Bronze  Black  White (Gloss)  Aluminum	Satin BZP BLP WHP SAP	Wrinkle BZW BLW WHW	AMG Aleutian Mountain G AQW Antique White BCM Black Chrome BGE Beige	er CMG C Granite CRI C CRM C HUG H MDS M er NBP M	Cascade Mountain Granite Cracked Ice Cream Hunter Green Mojave Desert Sandstone	RMG Rocky Mountain Granite SDS Sonoran Desert Sandstor SMG Sierra Mountain Granite TXF Textured Forest WCP Weathered Copper WIR Weathered Iron
LED Type e70 - e71 - Finish — NAT - BP - GP - NIC -	*For use with Remote BKSSL* Transform  3WLED/2700K	Powder Coat :  Powder Coat :  Powder Coat Since  Bronze  Black  White (Gloss)  Aluminum	Satin BZP BLP WHP SAP	Wrinkle BZW BLW WHW	AMG Aleutian Mountain C AQW Antique White BCM Black Chrome BGE Beige BPP Brown Patina Powde	er CMG C Granite CRI C CRM C HUG H MDS M er NBP M	Cascade Mountain Granite Cracked Ice Cream Hunter Green Mojave Desert Sandstone Natural Brass Powder	RMG Rocky Mountain Granite  SDS Sonoran Desert Sandstor  SMG Sierra Mountain Granite  TXF Textured Forest  WCP Weathered Copper  WIR Weathered Iron  Also available in RAL Finishes
LED Type  e70 -  e71 -  Finish —  NAT -  BP -  GP -  NIC -  BZW -	*For use with Remote BKSSL* Transform  3WLED/2700K	Powder Coat :  Powder Coat :  Powder Coat Color  Bronze  Black  White (Gloss)  Aluminum  Verde	Satin BZP BLP WHP SAP	Wrinkle BZW BLW WHW	AMG Aleutian Mountain C AQW Antique White BCM Black Chrome BGE Beige BPP Brown Patina Powde	er CMG C Granite CRI C CRM C HUG H MDS M er NBP M	Cascade Mountain Granite Cracked Ice Cream Hunter Green Mojave Desert Sandstone Natural Brass Powder	RMG Rocky Mountain Granite  SDS Sonoran Desert Sandsto  SMG Sierra Mountain Granite  TXF Textured Forest  WCP Weathered Copper  WIR Weathered Iron  Also available in RAL Finishes
LED Type  e70 -  e71 -  Finish —  NAT -  BP -  GP -  NIC -  BZW -	*For use with Remote BKSSL* Transform  3WLED/2700K	Powder Coat :  Powder Coat :  Powder Coat Color  Bronze  Black  White (Gloss)  Aluminum  Verde	Satin BZP BLP WHP SAP	Wrinkle BZW BLW WHW	AMG Aleutian Mountain C AQW Antique White BCM Black Chrome BGE Beige BPP Brown Patina Powde	er CMG C Granite CRI C CRM C HUG H MDS M er NBP M	Cascade Mountain Granite Cracked Ice Cream Hunter Green Mojave Desert Sandstone Natural Brass Powder	RMG Rocky Mountain Granite  SDS Sonoran Desert Sandsto  SMG Sierra Mountain Granite  TXF Textured Forest  WCP Weathered Copper  WIR Weathered Iron  Also available in RAL Finishes
LED Type e70 - e71 - Finish — NAT - BP - GP - NIC - BZW -  Option — CLR -	*For use with Remote BKSSL* Transform  3WLED/2700K	Powder Coat :  Powder Coat :  Powder Coat Color  Bronze  Black  White (Gloss)  Aluminum  Verde	Satin BZP BLP WHP SAP	Wrinkle BZW BLW WHW VER	AMG Aleutian Mountain C AQW Antique White BCM Black Chrome BGE Beige BPP Brown Patina Powde	der CMG C Granite CRI C CRM C HUG MDS N HOF NBP N Vider OCP C	Cascade Mountain Granite Cracked Ice Cream Hunter Green Mojave Desert Sandstone Natural Brass Powder	RMG Rocky Mountain Granite  SDS Sonoran Desert Sandsto  SMG Sierra Mountain Granite  TXF Textured Forest  WCP Weathered Copper  WIR Weathered Iron  Also available in RAL Finishes

DRIVER DA	NTΛ Inpu	ıt Volts	InRush Current Op 12A Max		Operating Current	Operation Ambient Temperature -22°F to 194°F (-30°C to 90°C)	
DRIVER DF	12VAC/E	OC 50/60Hz			700mA		
LM79 DAT	A				L70 DATA		
TEKA LED#	DELIVERED LUMENS	ССТ	INPUT WATTS (Typ.)	CRI (Typ.)	Minimum Rated	Life (hrs.) - 70% of initial lumens (L70)	
e70	82	2700	3	80		50,000	
e71	95	3000	3	80		50,000	
e72	104	4000	3	80		50,000	
e73	( <del>-</del>	Amber (590nm)	3	-		50,000	



General information Luminaire characteristics:

Power input: 12 to 22.1W

Lumens: 1370 to 1960 lm (delivered) Luminaire efficacy: 85 to 124 lm/W Source: White LED 3000K

Lumen maintenance: >80% of initial lumens at 100 000 hours (L80). LM-80 (LED) / LM-79 tested. Optics: Street optic, IESNA optics type II or III with comfort

optic for reduced glare. Adjustable +45°/-60° tilt and 337° pan. Body: Die-cast aluminum optical assembly and frame. Sodium-calcium tempered sealing glass, sealed at the factory. Stainless steel fastening components and hardware. Supplied with an aluminum mounting plate.


Electrical: Universal high efficiency electronic power supply, rated 50 000 H. 120V-277V.

Mounting: Wall arm, wall surface or ground spike. Finish: Gray (RAL9007). Weight: 4.9lbs (2.2kg). Warranty: 5 year limited warranty.


Certification: cULus listed for wet location.

Ratings: IP66, IK09.

# TYPE: X-5

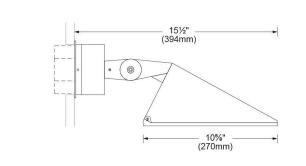

SIDE VIEW

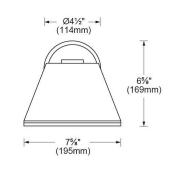

FRONT VIEW

9320 Boul. St-Laurent, suite 100, Montréal (Québec) Canada H2N 1N7 P.: 514.523.1339 F.: 514.525.6107 www.iguzzini-na.com



CLR - Clear Coat Protection (For use with Natural Finish only.)



MINI-MICRO™ RECESSED DOWNLIGHT™ TYPE: X-6

Example	A : s	- DM	- LED -	e10 -	AQW SP - MAC - 1:		1		
Material  Blank - Alumin B - Brass S - Stainle  Series  DM - Mini-P  Source  LED - 'e' Ter  LED Type  e38 - 3WLED e10 - 3WLED e11 - 3WLED	num sss Steel  Micro™ Rece chnology w	ssed Downliq ith Integral D e12	ght™		e14 - 3WLED/Blue e15 - 3WLED/Amber				
Optics*  SP - Spot (0 FL - Flood	(Blue Indicat								
SP - Spot (C FL - Flood	(Blue Indicat		Brass	Finish		F	remium Finish		
SP - Spot (C FL - Flood	(Blue Indicat		<b>Brass</b> Machined	Finish MAC	ABP Antique Brass Powder		<b>remium Finish</b> Cascade Mountain Granite	<b>RMG</b> Roci	ky Mountain Granite
SP - Spot ((FL - Flood) Finish Aluminu	(Blue Indicat	or)			ABP Antique Brass Powder  AMG Aleutian Mountain Grar	CMG			ky Mountain Granite oran Desert Sandston
SP - Spot (c FL - Flood Finish ————————————————————————————————————	(Blue Indicat m Finish Satin	Wrinkle	Machined	MAC		CMG nite CRI	Cascade Mountain Granite	SDS Son	
Finish  Powder Coat Color  Bronze  Black	m Finish Satin BZP	Wrinkle BZW	Machined Polished	MAC POL MIT	AMG Aleutian Mountain Gran	CMG nite CRI CRM	Cascade Mountain Granite Cracked Ice Cream	SDS Sono	oran Desert Sandston ra Mountain Granite
SP - Spot (6 FL - Flood  Finish  Aluminut  Powder Coat Color  Bronze	(Blue Indicat  m Finish Satin BZP BLP	Wrinkle BZW BLW	Machined Polished Mitique™ Stainles Machined	MAC POL MIT ss Finish MAC	AMG Aleutian Mountain Gran	CMG CRI CRM HUG	Cascade Mountain Granite Cracked Ice	SDS Sono SMG Sierr TXF Text	oran Desert Sandston
Finish  Aluminui  Powder Coat Color  Bronze  Black  White (Gloss)	m Finish Satin BZP BLP WHP	Wrinkle BZW BLW WHW	Machined Polished Mitique™ Stainles Machined Polished	MAC POL MIT ss Finish MAC POL BRU	AMG Aleutian Mountain Gran  AQW Antique White  BCM Black Chrome	CMG CRI CRM HUG	Cascade Mountain Granite Cracked Ice Cream Hunter Green	SDS Sono SMG Sierr TXF Text WCP Wea	oran Desert Sandston ra Mountain Granite tured Forest
Finish  Aluminur  Powder Coat Color  Bronze  Black  White (Gloss)  Aluminum	(Blue Indicate  m Finish Satin BZP BLP WHP SAP	Wrinkle BZW BLW WHW	Machined Polished Mitique™ Stainles Machined	MAC POL MIT ss Finish MAC POL	AMG Aleutian Mountain Gran  AQW Antique White  BCM Black Chrome  BGE Beige	CMG CRI CRM HUG MDS NBP	Cascade Mountain Granite Cracked Ice Cream Hunter Green Mojave Desert Sandstone	SDS Sono SMG Sierr  TXF Text  WCP Wea  WIR Wea  Also availa	oran Desert Sandston ra Mountain Granite tured Forest athered Copper


					×0071641 54		
LM79 DA	IA			L70 DATA	*OPTICAL DA		
BK No.	CCT (Typ.)	Input Watts (Typ.)	CRI	Minimum Rated Life (hrs.) 70% of initial lumens (L ₇₀ )	Beam Type	Angle	Visual Indicator
e38	2700K	3.0	90	50,000	Spot	16°	Green Dot
e10	3100K	3.0	90	50,000	Flood	33°	Blue Dot
e11	4100K	3.0	75	50,000			
e12	Red (627nm)	2.8	~	50,000			
e13	Green (530nm)	3.0	~	50,000			
e14	Blue (470nm)	3.0	~	50,000			
e15	Amber (590nm)	2.8	~	50,000			





**BEACON POLE MOUNT (BPM)** 

TYPE: X-7

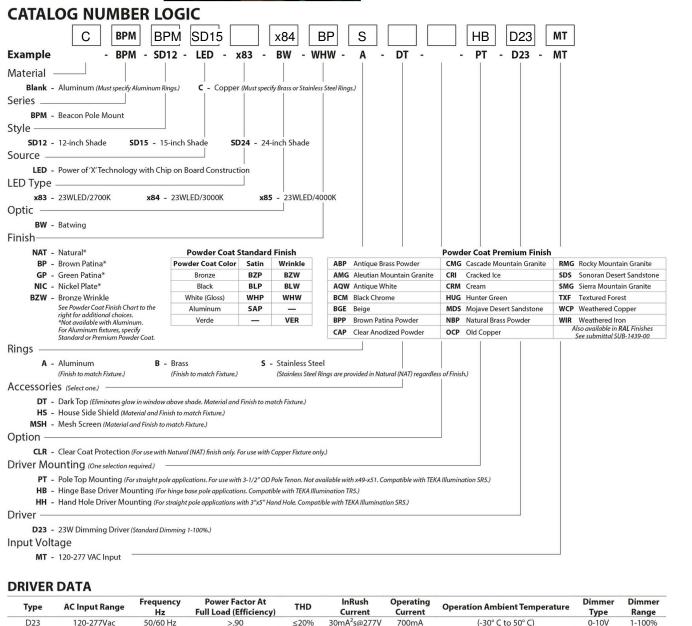

 
 Type
 AC Input Range
 Frequency Hz
 Power Factor At Full Load (Efficiency)
 THD
 InRush Current
 Operating Current
 Operation Ambient Temperature
 Dimmer Type

 D23
 120-277Vac
 50/60 Hz
 >.90
 ≤20%
 30mA²s@277V
 700mA
 (-30° C to 50° C)
 0-10V
 **LM79 DATA** L70 DATA

CRI (Typ.)

Minimum Rated Life (hrs.) - 70% of initial lumens (L70)

INPUT WATTS (Typ.)

expires 30 june 2019

OTTSDALE

DESIGNERS OF PROGRESSIVE ARCHITECTURE 7272 e indian school rd ste 214 scottsdale, arizona 85251 telephone 480 941 4222 www.dpaarchitects.com

REVISION INFORMATION #: Description:

drawn by: project no.: 18024 02/18/19

AS502 +

**EXTERIOR LIGHTING CUT-SHEETS** 

CITY OF SCOTTSDALE REZONING/DR DEVELOPMENT SUBMITTAL 24-ZN-2018 AND 52-DR-2018


iGuzzini

Key Notes (#)

- Planting area
   Raised steel planter
   Raised CMU planter w/ stone veneer

- 4. Fiberglass planter
   5. Site pottery
   6. Paver patio
   7. Synthetic turf
   8. Limit of overhead patio
   9. Existing city sign
   10. Laser cut steel fence to match

- 10. Laser cut steel fence to match architectural panels on building
  11. Concrete paving
  12. Patio wall 3" HT
  13. Patio gate
  14. Side walk ramp
  15. Step
  16. Existing palm
  17. Existing city catch basin to remain
  18. Fire Hydrant
  19. Utilities

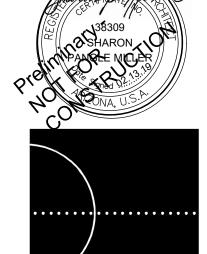

DESIGNERS OF PROGRESSIVE ARCHITECTURE 7272 e indian school rd ste 214 scottsdale, arizona 85251 telephone 480 941 4222 www.dpaarchitects.com

REVISION INFORMATION

	#:	Description:	Date:
,			

drawn by: team project no.: 1054.03

2019-02-13

HARDSCAPE PLAN

WestLand Resources

2020 N. Central Avenue
Suite 695
Phoenix, Arizona 85004
(602) 888-7000 CITY OF SCOTTSDALE REZONING DEVELOPMENT SUBMITTAL

PRE-APP CASE #488-PA-2018



7272 e indian school rd ste 214 scottsdale, arizona 85251 telephone 480 941 4222 www.dpaarchitects.com REVISION INFORMATION


drawn by:


LANDSCAPE PLANTING PLAN

SQ. FT. 71 SF

ARTIFICIAL GRASS


2020 N. Central Avenue Suite 695 Phoenix, Arizona 85004 (602) 888-7000 CITY OF SCOTTSDALE REZONING DEVELOPMENT SUBMITTAL PRE-APP CASE #488-PA-2018

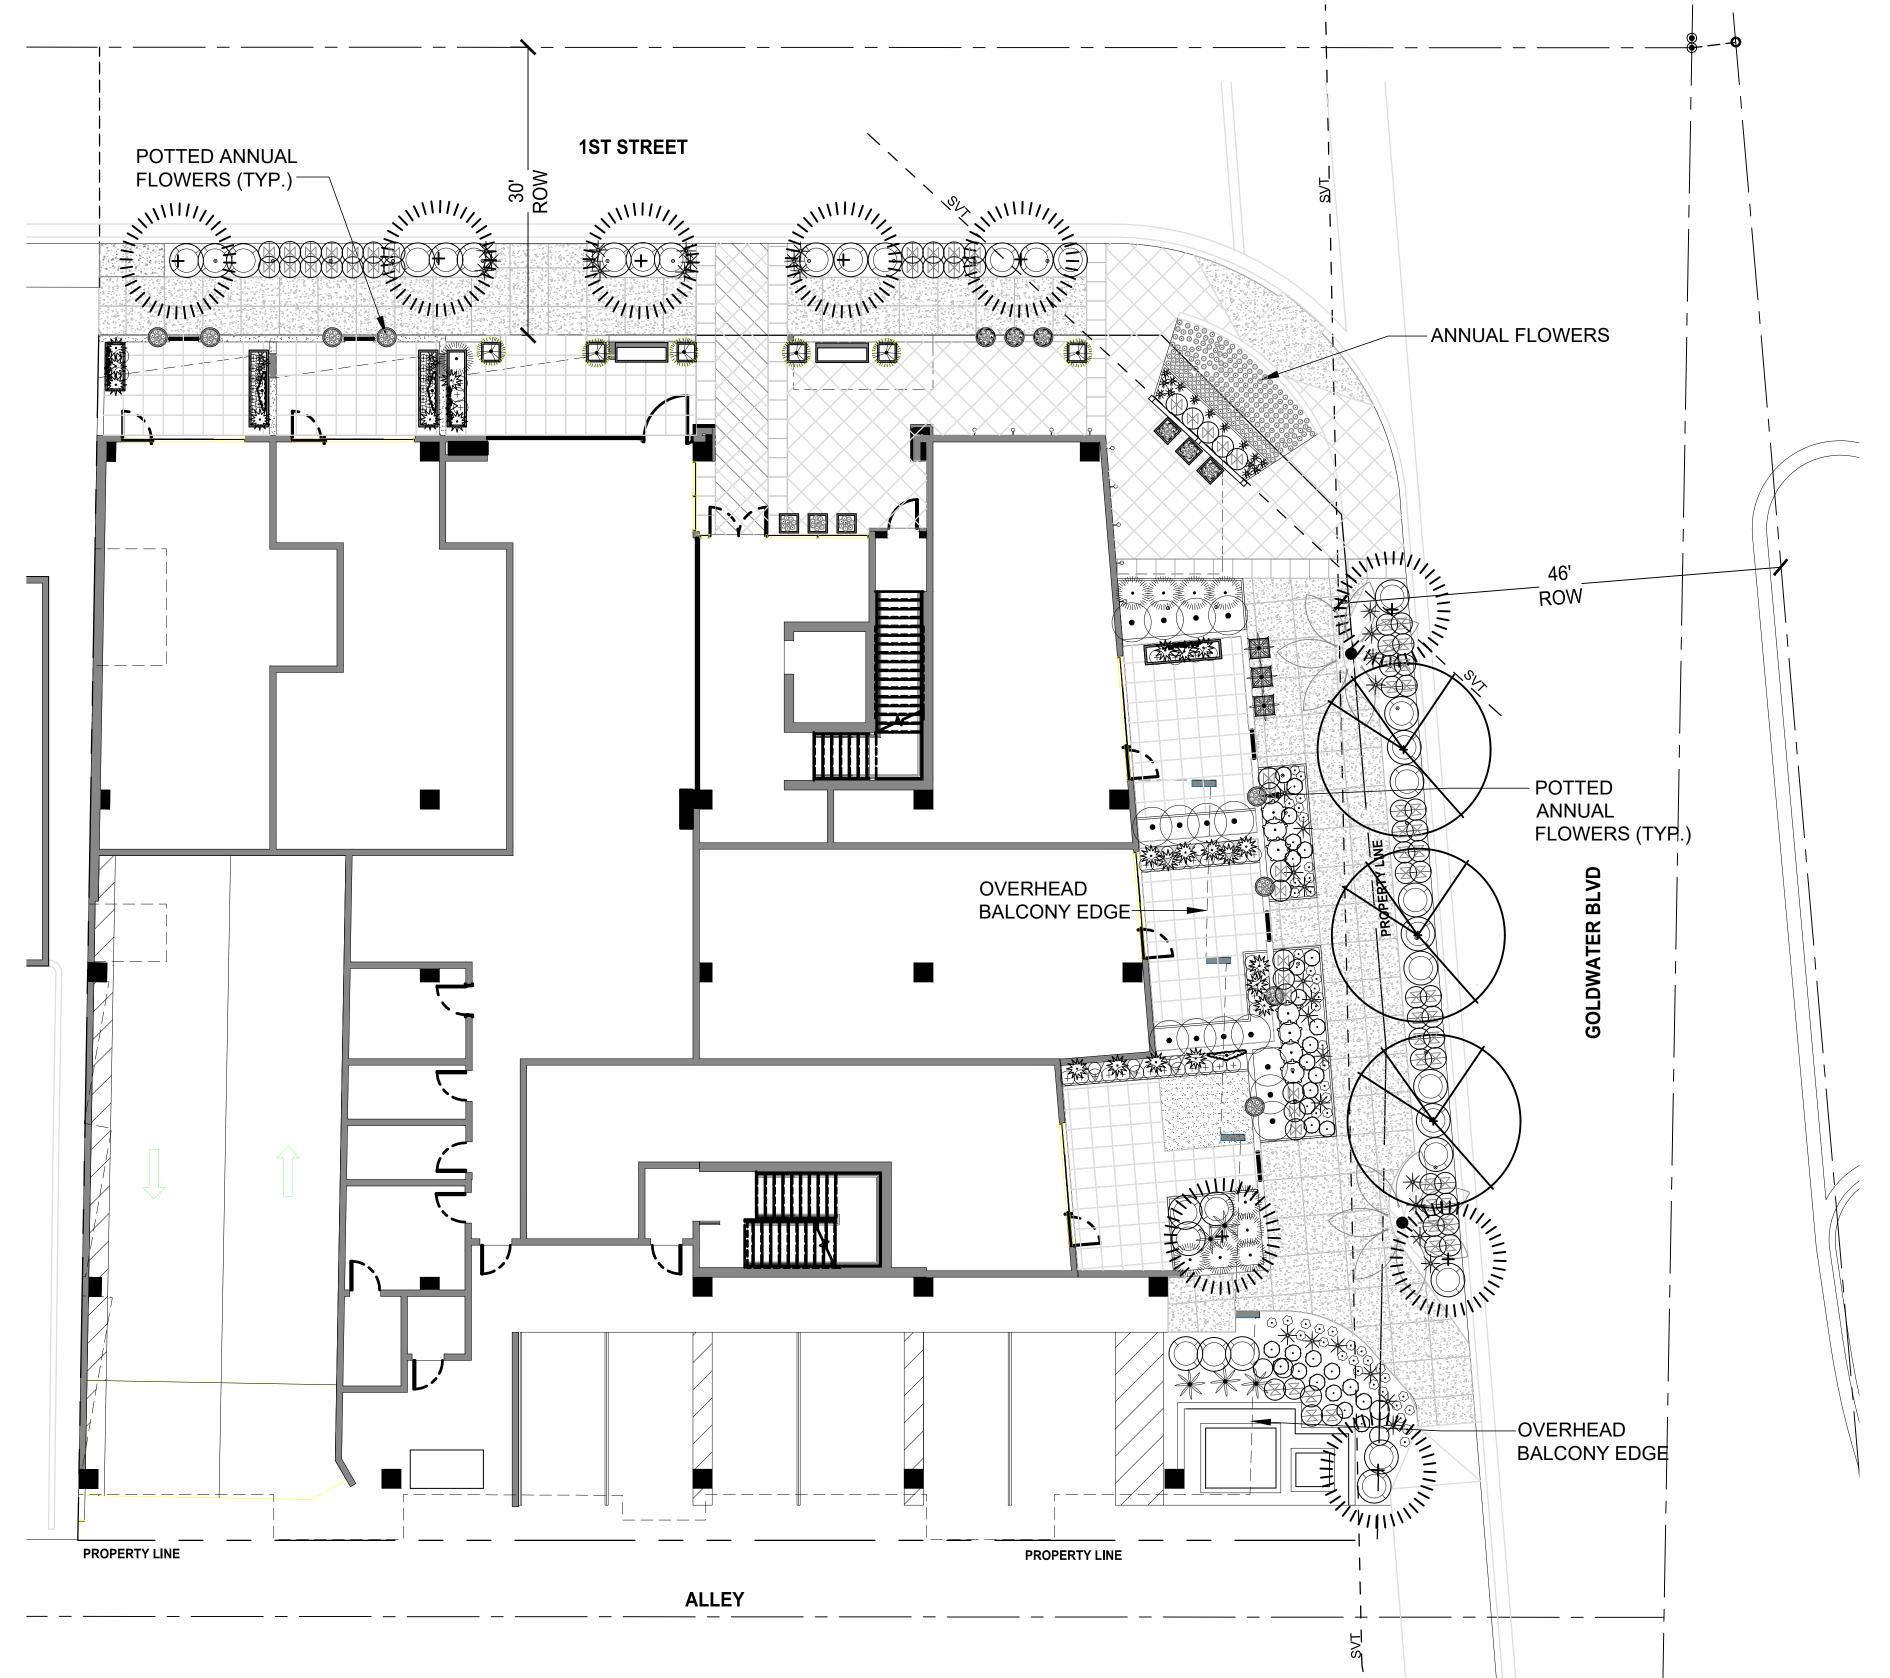

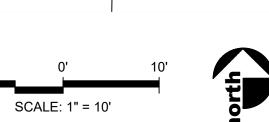

PLANT SCHEDULI TREES	BOTANICAL NAME	COMMON NAME	SIZE	QTY
	ACACIA ANEURA	MULGA	36" BOX	9
	CUPRESSUS SEMPERVIRENS 'TINY TOWER' TM	TINY TOWER ITALIAN CYPRESS	15 GAL.	6
	PROSOPIS X 'PHOENIX' TM	HYBRID MESQUITE	36"	3
	WASHINGTONIA SPECIES	EXISTING FAN PALM		2
SHRUBS	BOTANICAL NAME	COMMON NAME	SIZE	QTY
	AGAVE DESMETTIANA	SMOOTH AGAVE	5 GAL.	8
*	ALOE X `BLUE ELF`	ALOE	1 GAL.	23
$\bigcirc$	CALLISTEMON CITRINUS 'LITTLE JOHN'	DWARF BOTTLE BRUSH	5 GAL.	7
$\odot$	CHRYSACTINIA MEXICANA	DAMIANITA	1 GAL.	29
ZW.	DIETES VEGETA	FORTNIGHT LILY	5 GAL.	23
•	DODONAEA VISCOSA	HOPSEED BUSH	5 GAL.	15
	EREMOPHILA HYGROPHANA	BLUE BELLS	5 GAL.	74
*	HESPERALOE PARVIFLORA `BRAKELIGHTS` TM	BRAKELIGHTS YUCCA	1 GAL.	35
+	ILEX VOMITORIA 'STOKES DWARF'	DWARF YAUPON	1 GAL.	1
	RUSSELIA EQUISETIFORMIS	CORAL FOUNTAIN PLANT	5 GAL.	10
•	TETRANEURIS ACAULIS	ANGELITA DAISY	1 GAL.	46
$\bigoplus$	TEUCRIUM CHAMAEDRYS 'PROSTRATUM'	PROSTRATE GERMANDER	1 GAL.	1
ANNUALS/PERENNIALS	BOTANICAL NAME	COMMON NAME	SIZE	QTY
£ .	ANNUAL FLOWERS	ANNUAL FLOWERS	4"	411
GROUND COVER	BOTANICAL NAME  EREMOPHILA PROSTRATA `OUTBACK SUNRISE`	OUTBACK SUNRISE EMU	SIZE 1 GAL.	QTY 34
(+)	TRACHELOSPERMUM ASIATICUM `ASIATIC`	ASIATIC JASMINE	1 GAL.	34
	TRADESCANTIA PALLIDA	PURPLE HEART	1 GAL.	22
VINE/ESPALIER	BOTANICAL NAME	COMMON NAME	SIZE	QTY
	FICUS PUMILA	CREEPING FIG	15 GAL.	7
~~~~	GREWIA OCCIDENTALIS	LAVENDER STARFLOWER	15 GAL.	3
- Angle Carton	TRACHELOSPERMUM JASMINOIDES	STAR JASMINE	5 GAL.	3
INERT GROUND COVER	BOTANICAL NAME	COMMON NAME	SIZE	QTY
	DECOMPOSED GRANITE	3/4" - MADISON GOLD	SQ. FT.	2,323 SF
			1	

SYNTHETIC TURF

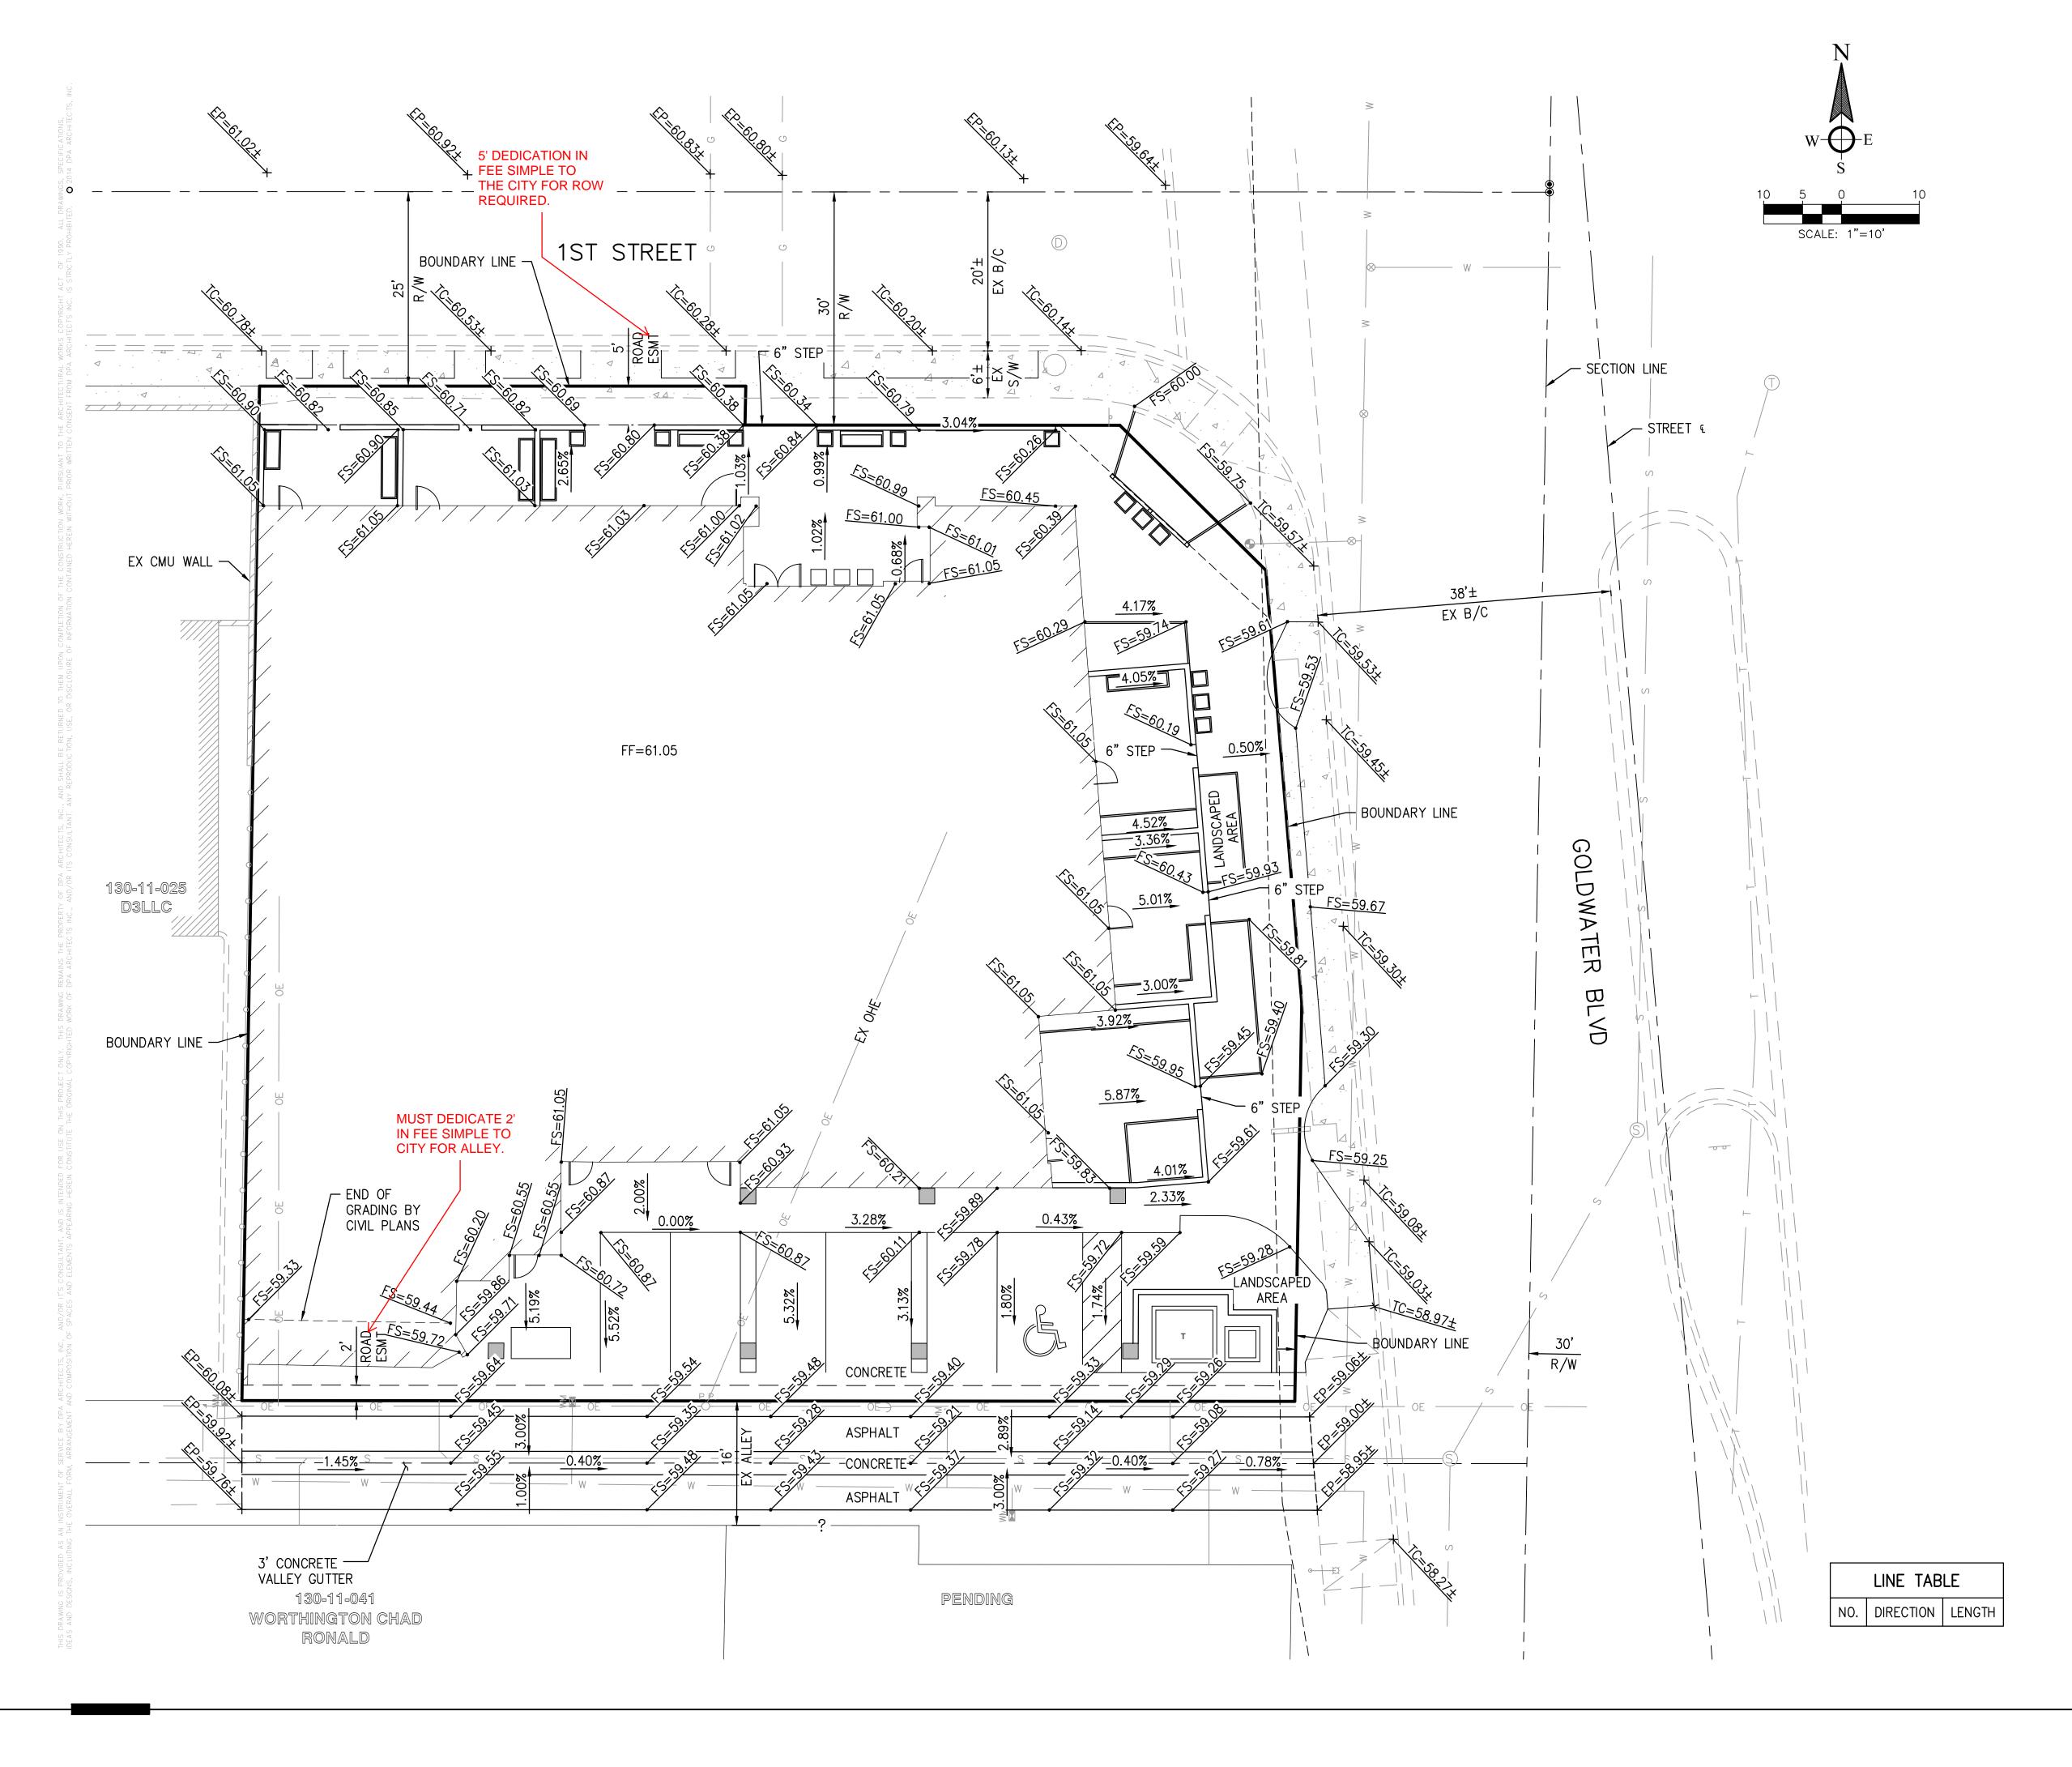

LEGEND

FS FINISHED SURFACE
ES EXISTING SURFACE
EP EXISTING PAVEMENT
TC EXISTING TOP OF CURB
CL CENTERLINE
PL PROPERTY LINE
ESMT EASEMENT
FF FINISHED FLOOR
CMU CONCRETE MASONRY UNIT
R/W RIGHT-OF-WAY
B/C BACK OF CURB


DESIGNERS OF PROGRESSIVE ARCHITECTURE 7272 e indian school rd ste 214 scottsdale, arizona 85251 telephone 480 941 4222 www.dpaarchitects.com

REVISION INFORMATION				
#:	Description:	Date:		
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1054.02 2/20/2019

PRELIMINARY GRADING PLAN

Bowman

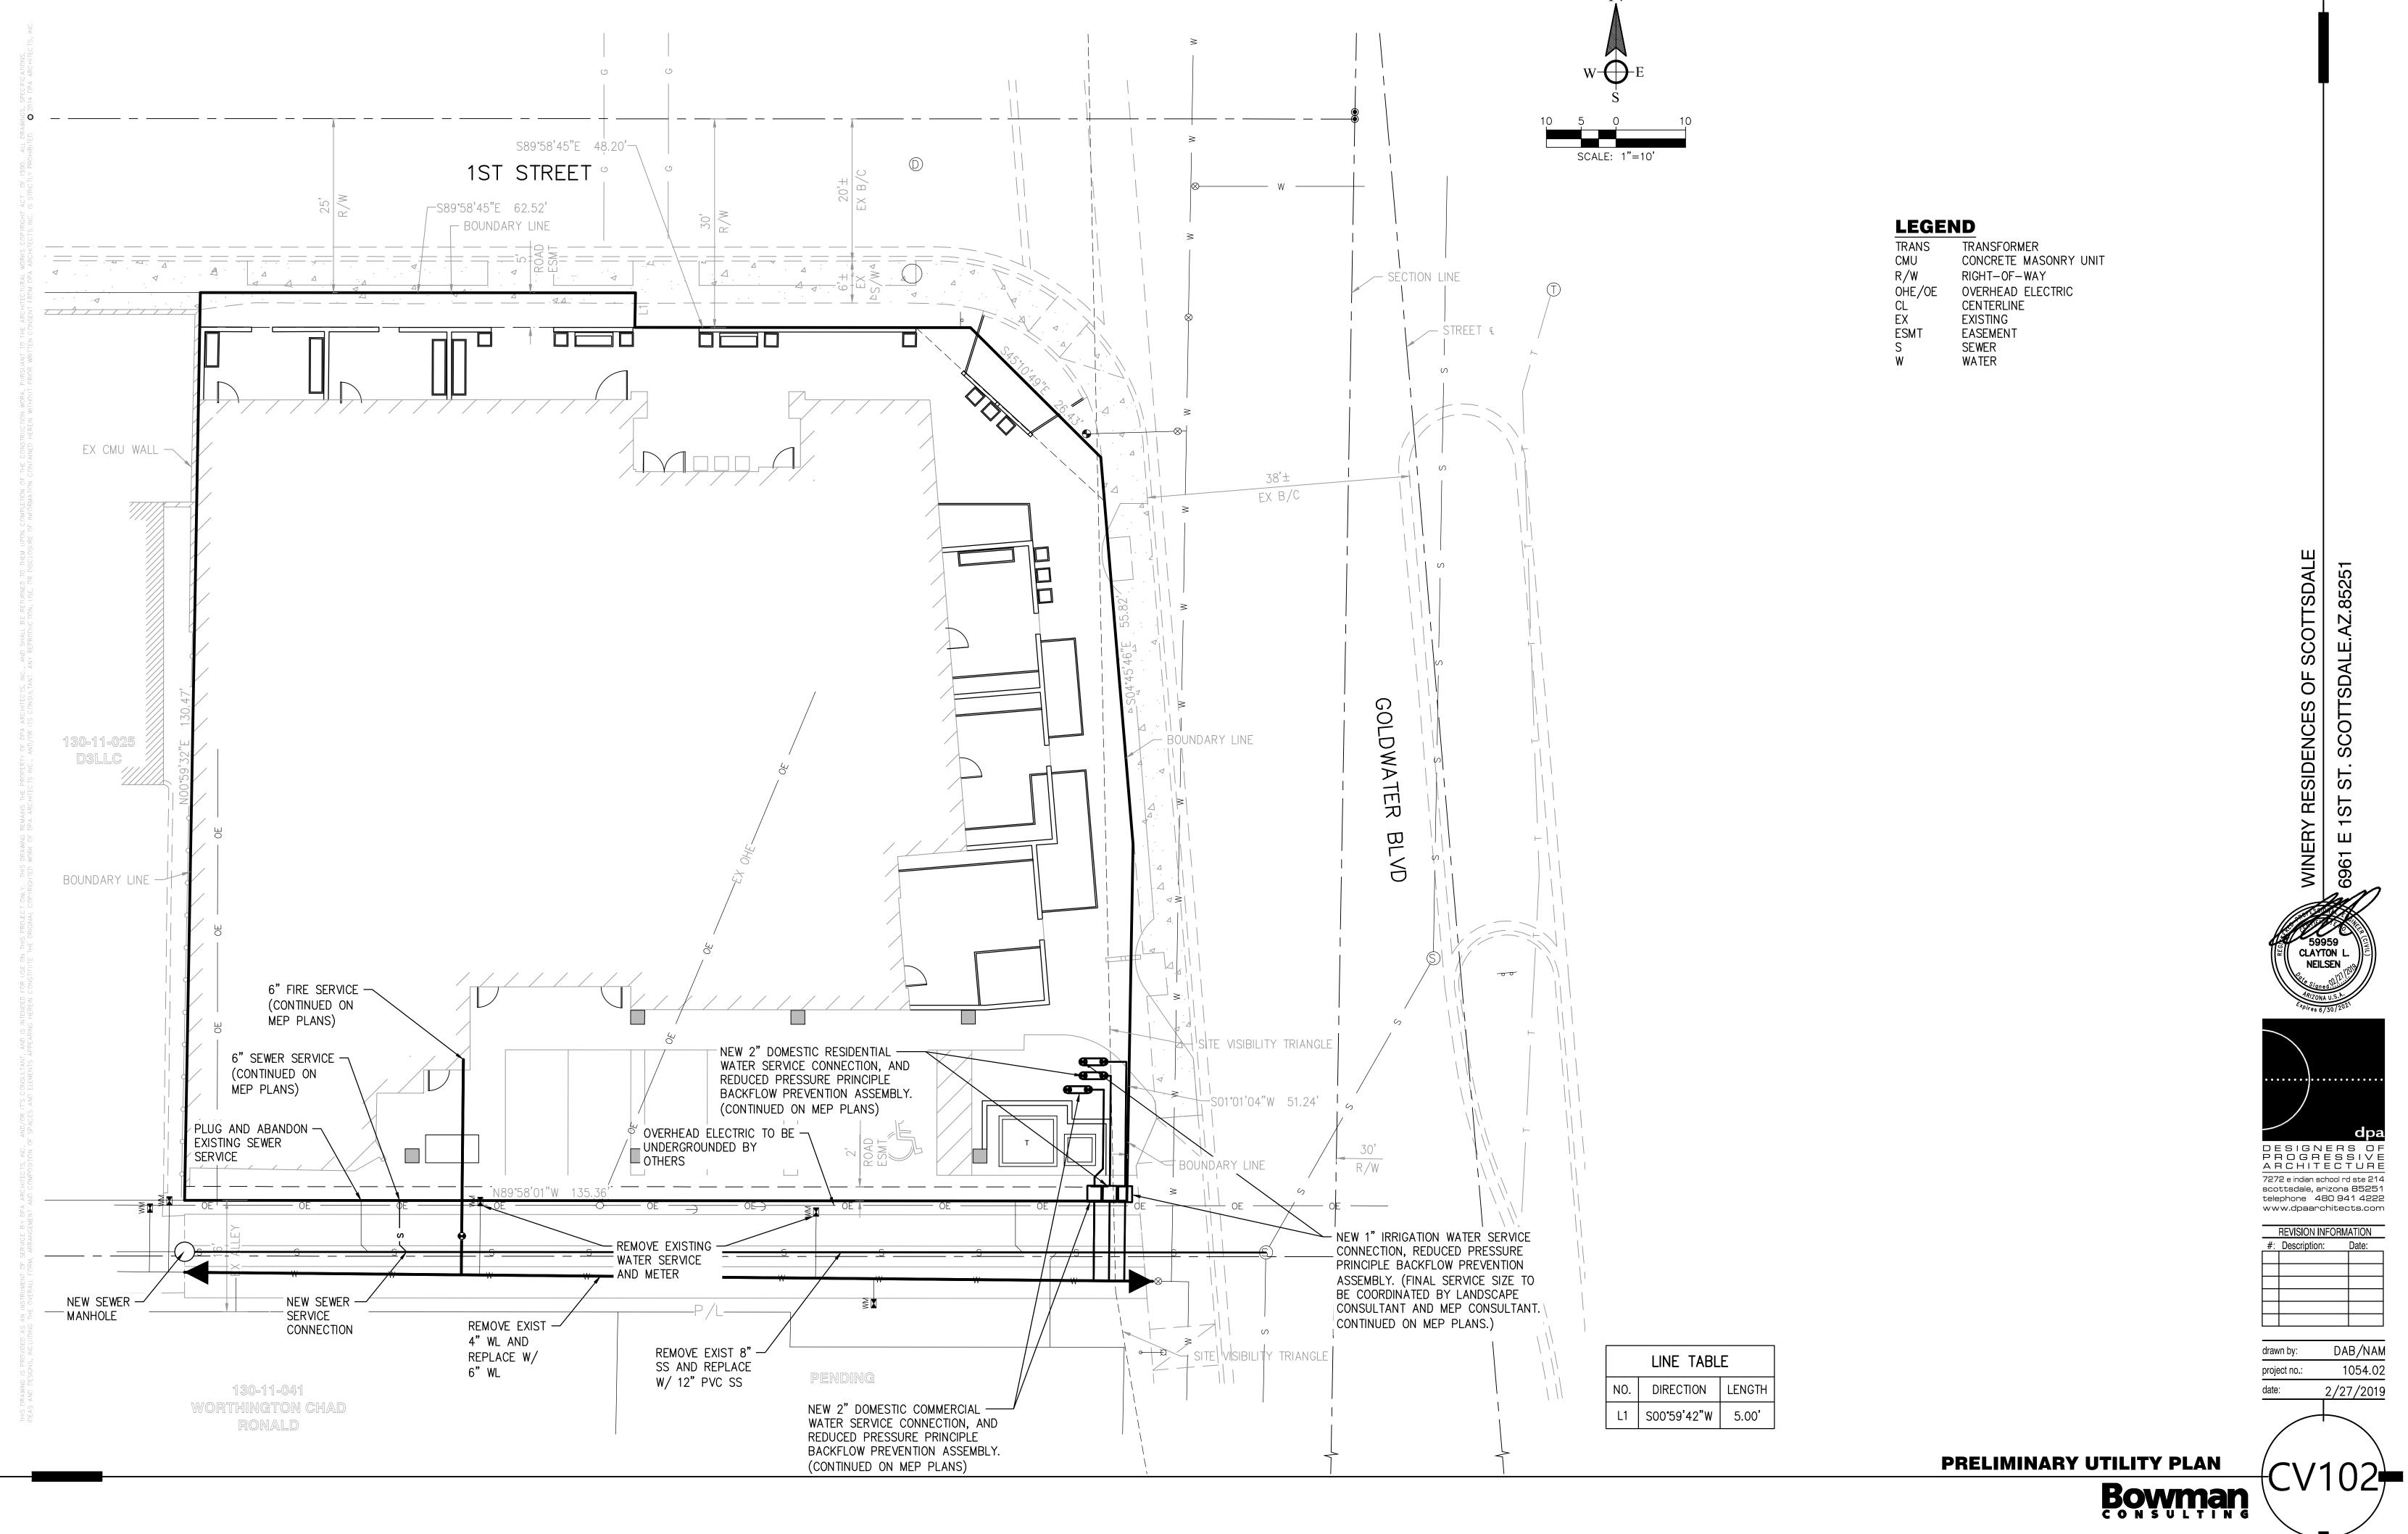

Winery Residences of Scottsdale

a mixed use residential development 6951 / 6961 1st Street Scottsdale, Arizona



- 1. Introduction
- 2. Development Plan
- 3. Conformance
- 4. Conclusion

1

Introduction

Overview:

Winery Residences of Scottsdale, a current partner within the Old Town Scottsdale business community is set to expand their operations at their existing property located at the SWC of 1st Street and Goldwater Boulevard. Fassco Investments is pleased to present a new, mixed-use, multifamily residential development consisting of 31 one-bedroom units planned for condominiums with flexible leasing terms to allow for Airbnb and VRBO type rentals if desired by the owners. The proposed project is approximately 51,884 sf and 4-stories in height. As part of this development plan Fassco is requesting a zoning change for the property from the current C-2/DO, D/OR-2/DO to DMU/Type 2 zoning designation. The overall height of the proposed project is approximately 48'- 0", below the Downtown zoning allowed maximum building height. The project uses consist of a Winery Market at street level with dwelling units at the street level and levels 2, 3, and 4. The fourth level will house a pool and amenity area which will serve the residents of the building. Twenty five of the projects 31 required parking spaces will be housed in a below grade parking garage with the remaining 6 required spaces located along the alley discretely screened from the public realm.

Location:

The project is located on the Southwest corner of 1st Street and Goldwater Boulevard at 6951 / 6961 East 1st Street Scottsdale. The adjacent properties to the West and Southeast are zoned D/OR-2, DO (Downtown Office Residential). A portion of the adjacent neighboring property to the Southwest is zoned R-5/DO (Multiple Family Residential). Across 1st Street to the North is Cornish Pasty, a successful restaurant and current neighbor. The Assessor's Parcel Numbers of the existing lots comprising the property are 130-11-024 and 130-11-023. The existing two lots will be legally assembled into one contiguous lot during the City's development review and approval of our project.

Relationship to Surrounding Properties:

The property's current address is 6951 / 6961 East 1st Street Scottsdale, Arizona 85251 located at the hard corner of 1st Street and Goldwater.



To the North: Located to the North, across 1st Street, is Cornish Pasty Restaurant.

To the West: Directly to the West is and existing two-story office building.

To the South: Directly South, across the alley is 'Psychic of Scottsdale' (commercial use operating within a residence) and a single family residence zoned R-5/DO Multiple Family Residential.

To the East: Immediately to the East is Goldwater Boulevard with Stagebrush Theatre located inboard from the East boundary of Goldwater. Case 13-ZN-2018 (Museum Square) is currently filed with the City for the 7-acre (+/-) property located between Stagebrush and the Scottsdale Artist School, south of Museum of the West. Museum Square proposes building heights up to 150 feet for hotel and residential uses.

2

Development Plan

Project Layout:

The project houses 31 dwelling units ranging from 712 to 992 square feet, all with private outdoor living spaces. All 31 units will be one-bedroom units containing a sleeping and living area, dining nook and kitchen. Parking for the dwelling units will be located in a sub-grade structure with additional surface parking available for the Street Level dwelling units.



As seen in the rendering above, the project fronts two public streets (1st Street and Goldwater Boulevard) creating a strong pedestrian connection and scale to the surrounding streetscape. The incorporation of five (5) street level dwelling units with generously sized patios with street

access / entries provides a 'brownstone-residential' urban response with a thoughtful transitioned connection between the dwelling unit and the public realm.

Connection to Existing Urban Fabric:

The Winery Residences of Scottsdale development will take the success of the existing property and business model and build upon its strong connection to the public streets and neighborhood. The project will serve as a catalyst to link future segments of redevelopment and streetscape improvements along 1st and Goldwater creating a more mature urban experience. The perimeter of our site incorporates outdoor living spaces (patios), and a dedicated landscaped pedestrian zone parallel with the each street frontage.

Architectural Character and Materials:

The proposed development conforms to the Downtown zoning district provisions as it relates to the facade plane alignments and building massing. The building design addresses the street setback expressing the urban edge to its maximum potential while still providing significant recesses and undulation across the base, body and parapet. Several building materials have been incorporated and layered across the façade length to create visual interest and variety. Consistent with the Scottsdale's Old Town Character Area Plan (OTCAP) the project utilizes a controlled soft, earth tone color palette which is contextual to its neighbors along 1st Street. The majority of building's mass is composed of soft neutral stucco colors ranging from soft off white at the hard corner progressing to deeper tones as it recedes from the intersection. This transition across the length of each façade breaks the massing down even further meeting the earth tone stucco color of our neighboring property to the West. In addition to the use of stucco, the project utilizes and locates higher end materials such as simulated stone and a wood detailed trellis at the street entry, tower element and hard corner. Essentially placing the

material upgrades at prime locations where both the public and the patrons of Winery Residences can appreciate them equally. The color palette is consistent with the other buildings in the area including our neighbor directly west and the darker grey earth tones of Cornish Pasty restaurant to the North. A bit more remote yet in our vicinity, the muted stucco colors of the Stagebrush Theatre are reflected on our palette. The building materials are consistent with those that are predominate in the area, including stucco, stone masonry, modest glazed window openings and steel / wood detailing.

Landscape Character and Materials:

Consistent with Scottsdale's Sensitive Design Principles, the plants and trees specified within the Winery Residences landscape plan will highlight the architecture and soften the site walls and vertical planes of the building. The varieties of species within the planting palette were chosen to provide year-round seasonal interest with the majority of species being low water use plants. All plantings within the public right of way are from the Arizona Department of Water Resources' Phoenix Active Management Area plant list. Planting areas within microclimates along the building's northern exposures, covered patios and along dwelling unit divider walls necessitates the use of shade tolerant shrubs, ground covers and vines. Raised planters with automatic irrigation and internal reservoirs are being utilized for most of the above grade plantings within microclimate areas to further the water efficiency of the landscape

The public hardscape on the project is largely limited to the hard corner of 1st Street and Goldwater which will be utilized as a street scape patio serving the Winery Market at Street Level. This area will have planting containers, seating arrangements and umbrellas for use by both the patrons of Winery Residences and customers of the market. The hardscape within the Street level dwelling unit courtyard patios will be a mix of pavers and synthetic turf providing a 'front yard' residential feel for its residents

3a

Conformance to the General Plan

The properties forming Winery Residences are designated as 'Mixed-Use Neighborhoods' on the 2001 General Plan and designated as Commercial C-2 and Downtown Overlay. With this inherent zoning in place Winery Residences is solid alignment with the General Plan's Goals and Approach.

The following narratives describe specific goals and policies with which this project reinforces the goals of the General Plan:

Land Use Element:

LU4: Maintain a balance of land uses that support a high quality of life, a diverse mixture of housing and leisure opportunities and the economic base needed to secure resources to support the community.

- Allow for a diversity of residential uses and supporting services that provide for the needs of the community.
- Provide a variety of housing types and densities and innovative development patterns and building methods that will result in greater housing affordability.

Response: This project will provide residents with access to Scottsdale's arts, cultural activity nodes and recreation areas. The one-bedroom unit designs offer an attainable option for those looking to live within or visit the Old Town Scottsdale community. The project is diverse as it's a smaller infill development which takes advantage of an underutilized site expanding on the successful business model already in place at the Winery Residences. The one-bedroom dwelling units fill a void that currently exists for smaller, more efficient residential units which,

due to their size, offer a competitively priced living option. The Winery Market planned at the Street level will offer products and services for the building's residents and customers within the surrounding neighborhood providing a pedestrian friendly retail environment to energize the street.

LU5: Develop land use patterns that are compatible with and support a variety of mobility opportunities/choices and service provisions.

- Integrate the pattern of land uses and mobility systems in ways that allow for shorter and fewer automobile trips and greater choices for mobility.
- Encourage non-motorized (pedestrian and bicycle) access/circulation within and to mixed-use centers to reduce reliance on the automobile.
- Provide a balance of live, work and plan land uses and development intensities
 that enable convenient non-automotive trips (pedestrian, cycling and transit)
 where environmentally and physically feasible.
- Encourage land uses with the highest intensity be located in areas conducive to alternative modes of transportation.

Response: This proposed project is an appropriate intensity for the area and within walking distance or bicycle ride to numerous entertainment, employment and civic facilities. The area is also served by mass transit inclusive of City bus routes, the Scottsdale Trolley, pedi-cabs and golf cart taxis which operate throughout the Old Town district.

LU6: Promote land use patterns that conserve resources such as land, clean air, water and energy, and serve all people within the community.

- Encourage a variety of compatible mixed-use land uses throughout the city in appropriate locations, allowing people to live, work, play and shop in the same general area.
- Concentrate future development in "growth areas" and other centers of activity, thereby discouraging sprawl, conserving energy, and promoting community identity.
- Protect and revitalize established areas/neighborhood by promoting new development and the adaptive reuse of existing community resources that reenergize an area.

Response: Winery Residences is within walking distance or a bicycle ride to numerous entertainment, employment and civic facilities. The area is also served by mass transit inclusive of City bus routes, the Scottsdale Trolley, pedi-cabs and golf cart taxis which operate throughout the Old Town district.

The proposed project will further enhance an area that contains several older single family homes located along side denser 2-story and taller commercial developments. Winery Residences will offer a unique housing option in a mixed-use setting for those who look to reside, work and enjoy the Old Town urban community. Bringing new inhabitants into an area of Scottsdale that is underutilized will help further energize a transitioning area of Old Town which is on the edge of the current growth pattern along Goldwater Boulevard. Our project will be an important link from the denser areas of Old Town to the less dense transitional areas along the Southern leg of the Goldwater couplet.

Economic Vitality Element:

EV7: Sustain the long-term economic well-being of the city and its citizens through redevelopment and revitalization efforts.

- Encourage and support the renovation and reuse of underutilized or vacant parcels/buildings/shopping centers.
- Enhance the experience for visitors who evaluate the quality of their experience through their visual impression of the community by revitalizing the mature built environment of businesses and neighborhoods.

Response: As noted above, the proposed project will help revitalize an area that contains several empty lots and buildings that have outlived their usefulness. The new development will be designed to offer a unique living experience for those who look to live, work or visit the community. The site is highly visible and the new development will continue to enhance the Old Town Scottsdale experience for both residents and visitors.

Housing Element:

HE2: Seek a variety of housing options that blend with the character of the surrounding community.

 Encourage energy efficiency via integration of the city's Green Building and Sustainability programs (or future programs) in new housing designs.

Response: The project will utilize green building strategies such as passive solar design and natural day lighting at the dwelling units. The project will promote the use of energy efficient systems and construction methods.

HE3: Seek a variety of housing options that meet the socioeconomic needs of people who live and work here.

- Encourage and establish appropriate incentives for development of aesthetically pleasing housing that will accommodate a variety of income levels and socioeconomic needs.
- Encourage energy efficiency via integration of the city's Green Building and Sustainability programs (or future programs) in new housing design as a contribution to long-term housing affordability and as a benefit to our environment.

Response: This new development will offer a high-quality housing option for those looking to reside and visit the Old Town Scottsdale community. With the smaller dwelling unit design the product will appeal to a much larger spectrum of potential users. To further facilitate the City's goals, the project will incorporate the use of energy efficient systems and construction methods wherever feasible.

Neighborhood Element:

NE1: Enhance and protect diverse neighborhoods so they are safe and well-maintained.

Provide for a range of housing opportunities.

Response: As noted above, the proposed project will assist in revitalizing an area that contains several empty lots and older housing options. The new development is designed to offer a unique housing option for those looking to reside or visit the Old Town Scottsdale community.

NE3: Sustain the long-term economic well-being of the city and its citizens through redevelopment and neighborhood preservation and revitalization efforts.

- Support and encourage appropriate public and private economic reinvestment in mature, physically and economically declining areas.
- Maintain and create opportunities for quality housing for all citizens. This is a crucial component of Scottsdale's local economy.
- Encourage Green Building techniques and alternatives that incorporate healthy, resource- and energy-efficient materials and methods in design, construction, and remodeling in conjunction with revitalization, neighborhood conservation and redevelopment efforts.

Response: The development of Winery Residences is an improvement on an already successful business in place on the property. Winery Residences is an existing, established neighbor to the surrounding community looking to further improve the property into a high-quality development. The project will utilize green building strategies such as passive solar design and natural day lighting at the dwelling units. The project will promote the use of energy efficient systems and construction methods wherever feasible.

Community Mobility Element:

CM2: Protect the physical integrity of regional networks to help reduce the number, length and frequency of automobile trips, to improve air quality, reduce traffic congestion, and enhance quality of life and the environment.

- Improve air quality by encouraging live, work and play relationships in land use decisions that reduce the distance and frequency of automotive-generated trips.
- Encourage alternative-fuel vehicles and examine alternatives for mobility options that will help air quality and the environment.

Response: This proposed project is located with access to numerous alternative modes of transportation and walking distance to many Old Town Scottsdale amenities, services and employment opportunities, which will minimize additional automotive traffic in the downtown core. The scale and location of the project promotes a pedestrian-oriented lifestyle that is increasingly popular as newer residential options become more varied and available within the Old Town area.

3b.

Conformance to the Old Town Character Area Plan (OTCAP)

The OTCAP "establishes the vision for Downtown Scottsdale" in order to "Maintain Downtown as the commercial, cultural, civic and symbolic center of the community comprised of urban neighborhoods that operate together as a highly-functional mixed-use center". There are many ways in which the proposed project aligns with that vision.

Following are several goals and policies with which our project aligns with the goals of the OTCAP.

Land Use:

Goal LU 1: Maintain Downtown Scottsdale as the commercial, cultural, civic and symbolic center of the community to ensure a vibrant mix mutually-supportive land uses.

- Policy LU 1.2. Maintain Downtown as a year-round, 24-hour highly functional mixed-use center, containing areas of different densities, architectural styles and land uses that support the needs of Scottsdale's residents and visitors.
- Policy LU 1.3. Maintain a balance of Downtown land uses that support a high
 quality of life, diverse mixture of housing and leisure opportunities, and the
 economic base needed to secure resources that support the community.

Response: This proposed project is located with access to numerous alternative modes of transportation and within walking and bike riding distance to Old Town Scottsdale amenities, services and employment opportunities, helping to minimize automotive traffic downtown. The soft, warm, contemporary design provides an aesthetic appropriate to the area. Through incorporation of stucco, wood and stone the design successfully bridges the gap between older single family homes and the newer multi-story developments in the vicinity.

The new development will be designed to offer a unique housing option in a mixed-use setting for those who look to live, work and visit the community. Adding additional inhabitants to the Old Town area will increase activity and strengthen the pedestrian atmosphere of the area, year-round 24/7. The incorporation of new customers within walking distance to local businesses will improve economics for existing nearby restaurants and service industries.

Goal LU 2: Promote the development of Downtown as a collection of mixed-use urban neighborhoods.

- Policy LU 2.1. As a general Plan designated Mixed-Use neighborhood,
 Downtown Scottsdale should offer efficiencies of strong access to multiple
 modes of transportation and major regional access and services, focus on
 human-scale development, accommodate higher density housing combined with
 complimentary office or retail uses, and accommodate vertical mixed-use
 structures.
- Policy LU 2.2. Support interconnected pedestrian-oriented urban neighborhoods that are comprised of a balanced mix of activities and land uses within optimal walking distance.
- Policy LU 2.5. Encourage new development, redevelopment and infill that strengthen Downtown Scottsdale's mix of uses and activities through the development of mutually-supportive land uses within the Downtown Multiple Use urban neighborhoods. Multiple Use areas include the majority of the properties within the overall OTCAP boundary.

Response: The Winery Residences proposal is located in an area with strong access to multiple modes of transportation and contributes to the desired balanced mix of activities and land uses for the area. The design of the project's streetscape is pedestrian-oriented, including public sidewalks and a supporting landscape palette.

This project is a high-quality infill project, aimed at improving upon the existing use of the property and the overall diversity of uses within the Downtown Multiple Use area. The development will provide high-quality dwellings in a mixed-use setting for those employees who want to live within walking / biking distance of their workplace in Old Town.

Goal LU 3: Continue the use of development types to guide the physical and built form of Downtown Scottsdale.

Policy LU 3.2. Support higher scale Type 2 development in all non-Downtown
 Core areas of the Downtown.

Response: This project is an appropriate scale development located within the Type 2 Downtown area. By promoting diverse Old Town housing options, this project contributes to the development of new multifamily residential with its loft-style dwelling units in a mixed-use setting. Moreover, as a sustainable infill project, it will create opportunities for a variety of income groups and enhance the successful use which already exists on the site.

Goal LU 6: Promote diversity in Downtown housing options.

- Policy LU 6.1. Develop a variety of housing types such as apartments, condominiums, lofts, town homes, patio homes, and live/work units.
- Policy LU 6.2. Recognize the need for housing developments that are large scale projects with numerous units and amenities, as well as small infill projects with a limited number of units.
- Policy LU 6.3. Encourage residential development for a variety of income groups.

Response: By promoting diverse Old Town housing options, this project contributes to the development of new multifamily residential with its loft-style dwelling units in a mixed-use setting. Moreover, as a sustainable infill project, it will create opportunities for a variety of income groups, enhancing the use which already exists on the site. The addition of a boutique-

style multifamily community on a corner lot will provide a developmental link along the Goldwater couplet facilitating future developers to replace vacant, under-utilized buildings with contemporary options for full-time residents and seasonal visitors desiring to experience the culture that Old Town Scottsdale has to offer.

Goal LU 7: Support a mix of land uses that promote a sustainable downtown.

- Policy LU 7.1. Support Downtown sustainability by encouraging vertical mixeduse development that offers land uses in close proximity to one another.
- Policy LU 7.2. Encourage development to make cost effective use of existing urban resources such as infrastructure systems, under-utilized sites, buildings, and transportation networks.

Response: By promoting diverse Old Town housing options, this project contributes to the development of new multifamily residential with its loft-style dwelling units. Moreover, as a sustainable infill development, it will create opportunities for a variety of income groups and enhancing the use which already exists on the site.

Character & Design:

Goal CD1: The Design Character of any area should be enhanced and strengthened by new development that promotes contextual compatibility.

- Policy CD 1.1. Incorporate, as appropriate, in building and site design, the
 distinctive qualities and character of the surrounding, and/or evolving context.
- Policy CD 1.2. Encourage creative and innovative civic and prominent developments to establish new urban design character and contextual

interpretations of the Downtown, for areas where development patterns are fragmented or are in transition.

Policy CD 1.8. Encourage new development and revitalization that is composed
of complementary and/or supportive design relationships with the established
urban form, as well as design features and materials of the neighborhoods within
which they are sited.

Response: The surrounding context is unique in that it's truly a mixed-use neighborhood with a limited commercial and service uses. The residential population is housed in a mix of new housing product and much older single family residential lots. The prevailing trend in Old Town is for the older housing product to be redeveloped and transitioned into denser patterns. This mixed-use development exemplifies being a good neighbor through enhancing a use (already in place on the property) transforming it into a more vibrant, modern, scale appropriate project.

The Winery Residences of Scottsdale development will further enhance a neighborhood fabric that is already experiencing significant transition to higher density projects with increased building heights.



Key factors which allow our proposal to integrate with the surrounding context successfully are the focus on pedestrian scale design elements, visual interaction with the street environment and the minimization of street level vehicles and parking. Through the incorporation of an underground parking structure, the proposed development goes great lengths toward minimizing parking as a design site element, reinforcing the pedestrian-oriented nature of the neighborhood and strengthening the connectivity to the Old Town area.

Goal CD3: Downtown development should respect and respond to the unique climate and context of the Southwestern Sonoran Desert.

 Policy CD 3.1. Enhance outdoor pedestrian comfort through microclimatic design that incorporates a variety of shade conditions, landscape and features that are drought tolerant, as well as offer attractive spaces, and passively cooler temperatures. Policy CD 3.2. Public realm and site design should incorporate techniques for efficient water use. Water, as a landscape element or design feature, should be used judiciously and place in locations with high pedestrian activity.

Response: The siting and orientation of the building has been designed with the pedestrian and occupants in mind, to create fully landscaped microclimates within the urban environment surrounding our site. This micro climate will serve to promote an overall sense of comfort and shade mitigating harsh temperatures we experience during the summer months. The majority of the building's exposure, where windows and patios are placed, face North and East. This orientation will allow the occupants to optimize their views and receive daylighting for each individual unit without the full use of interior shading mechanisms. The design of the building itself, through the use of cantilevered patios decks and floors, provides additional shade to the street level. The surface parking, located at the street level off the alley, is fully shaded by the floor structure above and away from the pedestrian experience. New trees in raised planter boxes at street level, spaced appropriately along 1st and Goldwater, will also provide filtered shade and softness to the mass of the building.

Goal CD6: Incorporate a regional landscape palette that complements Downtown's urban character.

- Policy CD 6.1. Downtown landscape elements should project a desert oasis design character, providing an abundance of shade, color, varied textures and forms.
- Policy CD 6.2. Landscape materials should complement Downtown's built environment, land uses, and activities through the careful selection of plan materials with regard to scale, density, placement, and arrangement.

Response: The goal of the landscape design is to provide a design to complement the building architecture, provide curb appeal and provide year-round seasonal interest for the residents as well as passersby. This will be accomplished with a densely designed planting plan that offers various layers of plantings to include low water use ground covers, shrubs, accent plants, and street trees, along with vines and seasonal annual flowers. These plantings will be installed within raised fabricated planters, site pottery and at-grade planting areas creating dimension and multiple layers of plantings throughout the site. Trees at street level are located to provide shade and to complement the building facade. Vines will be trained on the walls between patios to bring greenery to each unit and to soften the multi-story building at every level. Site pottery will be affixed to the street level low walls and planted with seasonal flowers twice yearly to give street views and resident patio views. Upper deck plantings are mindful of the views to Camelback Mountain. Plants overall, will be selected and designed with bloom season in mind, so that the property always has something beautiful happening in the landscaping.

Goal CD7: The extent and quality of lighting should be integrally designed as a part of the built environment.

- Policy CD 7.1. Achieve a balance between ambient light levels and designated lighting needs.
- **Policy CD 7.2.** Encourage lighting that is energy efficient and designed to serve both pedestrian and vehicular travel for safety in public/private spaces.

Response: The entire project will utilize LED lighting to minimize the energy consumption of the building and design with green principles in mind. The exterior of the property will have low level landscape lighting that will be designed to enhance the landscape material as well as the architecture without over-illuminating the facade. The landscape lighting and building lighting

will be coordinated to ensure that the photometrics for the site include all sources from the project, as well as existing street lighting.

Goal CD8: Implement high-quality design in Downtown architecture.

- Policy CD 8.1. Encourage contemporary and historical interpretations of regional Southwestern Sonoran Desert architectural traditions.
- Policy CD 8.2. Promote the "Scottsdale Sensitive Design Principles" in the creation of architecture in Downtown.
- Policy CD 8.3. Promote the principles of design in the "Downtown Urban Design and Architectural Guidelines" in all Downtown development.

Response: It is the goal of both the design and development team to produce a truly exciting product to complement the ever more diverse and invigorated Old Town area. The distinctiveness of the design focusing on green technology, minimal foot print, lack of visible surface parking, reduction of urban heat island, deeply shaded private and common areas, etc. all contribute to what we believe will be an innovative instance of the revitalization of an underutilized site that exemplifies modern urban desert architecture.

The proposed materials and architecture and how they are integrated with their surroundings create a contemporary desert sanctuary with a sensual quality lacking in comparable developments in this market. When completed, this first-rate, sustainable design competitively priced, will hopefully become a model which inspires similar development in the area.

Goal CD9: Development should incorporate sustainable building practices and products.

- Policy CD 9.1. Development should strive to incorporate sustainable planning, design strategies, building techniques, and the use of durable indigenous materials, to minimize environmental and maintenance impacts, and endure over time.
- Policy CD 9.2. Encourage green building design strategies such as building orientation, passive solar response, natural day lighting, passive cooling techniques, and the integration of regional plan materials.
- Policy CD 9.3. Promote the use of energy efficient systems, construction methods, and alternative energy sources.

Response: Our intention is to prove that sustainable and responsible design can be both aesthetically and financially appealing. The development will institute green building techniques including building orientation, passive solar design, natural day lighting, and passive cooling strategies. The project team will also mandate the use of energy efficient systems, and construction methods.

Economic Vitality:

Goal EV1: Support Downtown's economic role as a hub for arts, culture, retailing, entertainment, tourism and events.

 Policy EV 1.4. Promote Downtown as a creative environment in which people can live, work, and purse leisure activities.

Response: The new development will be designed to offer a unique housing option for those who look to live, work and visit the community. Bringing additional inhabitants to the Old Town

area will increase activity and strengthen the pedestrian atmosphere of the area, year-round 24/7. The incorporation of new customers within walking distance to local businesses will improve economics for existing nearby restaurants and service industries.

Goal EV2: Promote private investment and attract new development to downtown.

- Policy EV 2.1. Encourage new development and reinvestment that maintains
 Downtown's economic edge in the region.
- Policy EV 2.2. Promote a mix of daytime/nighttime activities year-round through new development that includes vertically mixed land uses and a diverse range of housing development.

Response: By promoting diversity in Old Town housing options, this project contributes to the development of variable housing types with townhouses. Moreover, as a sustainable infill project, it will create housing for a variety of income groups and makes use of an otherwise under-utilized site.

The new development provides an additional housing option for those who look to live, work and visit the community. Adding additional inhabitants to the Old Town area will increase activity and strengthen the pedestrian atmosphere of the area, year-round, day and night, creating a continuity of use which extends beyond normal use cycles.

3c.

Conformance to Downtown Urban Design & Architecture Guidelines


The primary purpose of the Downtown Urban Design & Architecture Guidelines is to guide the overall aesthetic of new projects so that the qualities that presently exist in Old Town Scottsdale are maintained and align with the vision. There are several ways in which this project meets the goals of the above-mentioned guidelines.

Below is a cross section of the strategies and policies with which this project reinforces the goals of the Downtown Urban Design and Architecture Guidelines:

Site Development:

A2. Active Street Frontages:

 Design active building frontages to create inviting indoor and outdoor spaces visible from the sidewalk and street.

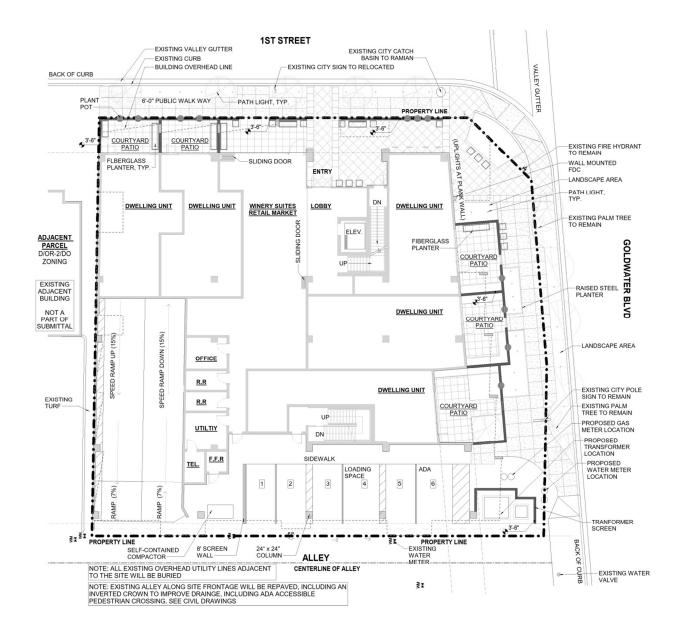

Response: Active building frontage design is provided at both the 1st Street and Goldwater Boulevard streetscapes. This has been achieved through the incorporation of a Winery Market, courtyard patios and exterior hardscaped seating areas. The connection to the street is further reinforced through the use of the market's full height operable window which will allow both the public and building inhabitants to enter the Winery Market / Building Lobby through a wider than usual opening right off the public sidewalk.

A4. Parking Facilities:

- Minimize the visual impact of parking structures and parking lots by locating them at the rear or interior portions of building sites.
- Parking access from alleys and side streets is desired. The number of entrances
 to parking facilities from other streets, especially major arterials, should be kept
 to a minimum.

Response: The project's parking is ideally located to minimize visual impact from Goldwater Boulevard and 1st Street. Both the underground parking and surface parking spaces are accessed from the existing alley away from the public / pedestrian realm.

A5. Building Equipment and Services:

- Locate service and loading zones to minimize visibility from public streets.
- Mechanical and electrical equipment, solar collectors, satellite dishes and communications equipment should be concealed from view of public streets and neighboring properties.

Response: The building's service entry and loading zone is located at the rear of the property accessed from the existing alley. All HVAC equipment is located at the Roof Level and screened behind a parapet wall, concealed from public view.

A8. The Continuity of Street Spaces:

- Buildings should create consistent street setback patterns by locating a maximum amount of their front elevation on the setback line.
- The preferred building-street relationship is to place buildings parallel to the street.

Response: A consistent and architecturally pleasing street setback pattern has been incorporated by maximizing the percentage of the elevation placed at the building setback line. This applies to both 1st Street and Goldwater street frontages. In addition, both building elevations are parallel with the street setbacks creating an urban edge along the project's perimeter.

A9. The Building Setback Zone:

- The building setback zone should be developed as a "patio" landscape designed primarily for pedestrian activity and enjoyment.
- Expanses of lawn should be avoided.

Response: The Goldwater building setback zone has been designed as a series of low walled courtyard patios connecting with the pedestrian activity sidewalk directly parallel with it. The hard corner and 1st street frontage will act as a public table/seating area for both the Winery Market customers and the building's inhabitants. This will be the most active portion of the building setback zone. Expanses of lawn have been avoided at both street frontages.

Building Form:

B1. Reduction of Apparent Size and Bulk:

- Downtown buildings of three or more stories should be designed as carefullyorchestrated compositions of smaller parts. Every building should reduce its
 perceived height and bulk by dividing the building mass into smaller-scale
 components.
- Large or long continuous wall planes should be avoided. As a general principle,
 building surfaces over two stories high or 50 feet in length should be relieved
 with a change of wall plane that provides strong shadow and visual interest.



Response: The building design incorporates multiple areas of façade projections and recesses which effectively reduce the mass of the building. There are various changes in wall plane at each level of the building's composition. In juxtaposition to the horizontal nature of the façade, the levels of the building are visually tied together through the use of rhythmic vertical wall planes which provide visual privacy between the units.

Architectural Character:

C1. Proportion and Scale

 Development proposals should demonstrate evidence they have studied the predominant scale and proportions of buildings in the district and street where they are to be located.

Response: As preferred by the guidelines, the building has been designed with horizontal emphasis to minimize the building's height. Our proposal is contextual with district given that it responds to both its single family residential neighbors and larger, taller developments in the district. Winery Residences aesthetic has a residential character, scale and texture. The residential feel is equally incorporated at the street level while the massing of the upper floors speaks well, contextually, to district neighbors such as Main Street Plaza, Museum of the West, Valley Ho and the recently completed Eldorado on 1st.

C2. Building Materials

- Restraint should be used in the number of different building materials selected.
 Simplicity of palette is desired.
- Building materials similar to those in predominant use on the street or in the district of the new project are encouraged.
- Wall detailing should recess glass surfaces in shadow as deeply as possible within the limits of the selected construction systems.
- Highly reflective materials that create glare should be avoided.

Response: The building has been designed to minimize the number of exterior materials while providing enough variation in the form of the building to create interest. The predominant

material used across our building facade will be portland cement stucco and EIFS. Stucco can be found as one walks along 1st Street beginning with our neighbor directly to our West. Stucco and EIFS, as materials, can serve residential and larger scale buildings equally well when used and detailed properly. Stucco will be used, for the most part, at the Street Level exterior facade and public realm for its depth, pedestrian level character and durability. The EIFS portions will be used at the exterior walls of the units on levels 2, 3 and the roof. Complementing the stucco and EIFS will be stone veneer, wood detailing, steel railing organic accents and horizontal wood-like stone planking. These accent materials are used sparingly and strategically at the points of the most impact but do not dominate the primary stucco material. The glazed openings on the project have been recessed, typically, as much as possible from the exterior surface of the wall. Giving each unit's window return a minimum of 4" recess at the window jamb and head conditions.

C3. Color and Texture

- Building colors should emphasize light and muted colors, with light earth tones dominant.
- Color selection should show evidence of coordination with the predominant use of color on the street and district of the new project.

Response: Winery Residences color palette fully supports the muted earth tone goals described within the City design guidelines.

C4. Architectural Detail

 Surface detail, ornament and other elements that enrich architectural character are encouraged. **Response:** Material selections such as the laser cut steel railing panels, stone veneer, planking and wood details provide adequate surface ornament described above.

Landscape Character:

D1. Streets

- Plants, street furniture, paving and other landscape elements should be organized along streets to create a unified civic appearance. The materials and layout of these elements should conform to City standards.
- A safe, comfortable pedestrian environment should be created as a result of creative street frontage design. Give primary consideration to provision of ample shade, special paving, and buffer between the street and walking space.

Response: The civic presence along Winery Residences public streets (1st Street and Goldwater) is a thoughtful design using several elements to reinforce the pedestrian experience. Low level steel planter boxes terracing up to stone veneer clad patio walls and planting containers provide a landscape tapestry with architectural depth. The pedestrian sidewalk which follows the street curb provides a safe comfortable design along with its connection with the on property patio seating areas and gathering spaces. One can weave in and out of the public-private realm without feeling any harsh transitions, similar to the existing property as exists today. Winery Residences wants to welcome the public into its 'front door' with attractive landscape arrangements, textural walls and pottery arrangements. Paver floor tiles have been specified for the majority of the onsite hardscape areas providing intimate detailing as one enters into our project from the City sidewalk. The paver floor tiles are also located at the dwelling unit patios creating visual consistency.

D2. Site Spaces

- Landscaping for individual sites should provide shade, opportunities to rest, adequate lighting and relief from traffic noise.
- Design for outdoor spaces should address special site conditions such as solar orientation and relationship to the street, neighboring building and neighboring offsite spaces.
- Landscape elements should relate closely to the character, materials and function of site architecture.

Response: The outdoor spaces of Winery Residences have been designed to create an urban pedestrian retreat offering residents and the public relief from the desert environment. The solar orientation of the building is optimum for both shaded patio environments and operable window wall openings which will connect our project to the street. The project's North and East facing facades will provide a comfortable respite from the harsh Arizona sun and heat island effect. Whether it is the dwelling unit patios or the streetscape seating areas we believe pedestrian activity will be the norm at Winery Residences.

D3. Plant Selection

- The plant palette for individual projects should reinforce Downtown's character
 as an urban oasis by emphasizing plants that provide shade, year round color
 and a variety of textures and forms.
- The selection and layout of plant materials should optimize each species' growth potential by recognizing its special environmental and maintenance requirements.

 Planting design for use in Downtown projects should respect the need for water conservation.

Response: The goal of the landscape design is to provide a design to complement the building architecture, provide curb appeal and provide year-round seasonal interest for the residents as well as passersby. This will be accomplished with a densely designed planting plan that offers various layers of plantings to include low water use ground covers, shrubs, accent plants, and street trees, along with vines and seasonal annual flowers. These plantings will be installed within raised fabricated planters, site pottery and at-grade planting areas creating dimension and multiple layers of plantings throughout the site. Trees at street level are located to provide shade and to complement the building facade. Vines will be trained on the walls between patios to bring greenery to each unit and to soften the multi-story building at each level. Site pottery will be affixed to the street level low walls and planted with seasonal flowers twice yearly to give street views and resident patio views. Upper deck plantings are mindful of the views to Camelback Mountain. Plants overall, will be selected and designed with bloom season in mind, so that the property always has something beautiful happening in the landscape

Conclusion:

Winery Residences of Scottsdale successfully demonstrates how a smaller, under-utilized site can be re-developed to continue serving as an architectural asset to the Old Town community. It's unique that an existing business, in place, can reinvent itself and mature without having to change address. Winery Residences has been a strong neighbor to its surrounding community and through this project will continue to do so for years to come. Our goal with this proposal has consistently been, to improve on while respecting what exists on site currently. It's important that Winery Residences remains a connected residential project. The Market mixed use at our street level will do this, serving as a hub for the multiple residential projects existing and planned along 1st Street. We are a corner property and have responded with a design that holds the urban edge yet opens its interior to the street.

As demonstrated in the narrative, the project is in conformance with the City of Scottsdale's General Plan, the Old Town Character Area Plan and the Downtown Urban Design and Architecture Guidelines.